

8163 Rochester Avenue Rancho Cucamonga, CA 91730 P. +1 909-987-0909 PBK.com

October 6, 2023

TO : All Bidders FROM : Bob Lavey

PROJECT: Nogales High School Interim Locker and Restroom Portables

Project 230384.41

SUBJECT: Addendum 2

DSA : 04-123338 / File 33-13

The following changes, omissions, and/or additions to the Project Manual and/or Drawings shall apply to proposals made for and to the execution of the various parts of the work affected thereby, and all other conditions shall remain the same.

Careful note of the Addendum shall be taken by all parties of interest so that the proper allowances may be made in strict accordance with the Addendum, and that all trades shall be fully advised in the performance of the work which will be required of them.

Bidder shall acknowledge receipt of this Addendum in the space provided on the Bid Form. Failure to do so may subject Bidder to disqualification.

In case of conflict between Drawings, Project Manual, and this Addendum, this Addendum shall govern.

2. PROJECT MANUAL

2.0 Include the attached Addendum 2 by Ledesma & Meyer Construction Company, Inc. dated October 11, 2023 as part of the Project Manual.

DRAWINGS

Architectural

- 2.1 DRAWING A1.1 OVERALL SITE PLAN
 - A. Relocated the new drinking fountain per the attached Drawing A1.1.
- 2.2 DRAWING 1.2 ENLARGED SITE PLAN
 - A. New Site Plan 6: Added note for existing chain link fence to remain per the attached Drawing A1.2.
 - B. Detail 7: Added note for existing wheel stop to be removed per the attached Drawing A1.2.
 - C. Detail 20: Revised reference for concrete footing per the attached Drawing A1.2.
 - D. Detail 23: Added notes for pipe size and anchorage per the attached Drawing A1.2.
 - E. Revised detail reference on Keynote 0107 per the attached Drawing A1.2.
 - F. Added note for contractor to provide restroom signage per the attached Drawing A1.2.
 - G. Added note for contractor to provide Haws Drinking Fountain Model H1117.8 per the attached Drawing A1.2.

Addendum 2 Nogales High School Interim Locker and Restroom Portables Project 230384.41 DSA 04-123338 / File 33-13 October 6, 2023 Page 2

Civil

2.3 DRAWING C1.01 UTILITY PLAN

A. Added two cleanouts and thrust blocks with a detail per the attached Drawing C1.01.

Electrical

- 2.4 DRAWING E0.1 ELECTRICAL GENERAL NOTES AND SYMBOLS
 - A. Detail 1: Added Note 6 per the attached Drawing E0.1.
 - B. Detail 2: Removed detail per the attached Drawing E0.1.
 - C. Revised the Electrical Symbol List per the attached Drawing E0.1.
- 2.5 DRAWING E1.1 POWER SITE PLAN
 - A. Revised Reference Notes 4 through 6 to be existing per the attached Drawing E1.1.
- 2.6 DRAWING E1.2 SIGNAL SITE PLAN
 - A. Revised Reference Notes 4 and 8 along with General Note 3 per the attached Drawing E1.2.
- 2.7 DRAWING E2.1 FIRE ALARM PLAN
 - A. Revised Reference Notes 2 through 7, revised General Notes and Signal Reference Notes per the attached Drawing E2.1.
- 2.8 DRAWING E4.1 SINGLE LINE AND AV WIRING DIAGRAM
 - A. Revised Single Line Diagram and revisions to reference notes 1 and 3 per the attached Drawing E4.1.

END OF ADDENDUM 2

Submitted by,

BOB (AVEY AIA, LEED AP


Managing Partner, Architect

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Attachment: Drawings A1.1, A1.2, C1.01, E0.1, E1.1, E1.2, E2.1, E4.1

No. C28020 EXP. 1/31/25 October 11, 2023

ADDENDUM NO. 2

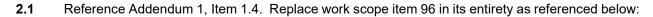

Work Scope Item 96 - The General Contractor shall be responsible to provide and install the interior drinking fountain indicated on plan A1.1 and Details on 23/A1.2 and CMSK-4. General Contractor YES

2.2 Add in its entirety CMSK-4 with the attached.

Included Attachments:

- CMSK-4 - Drinking Fountain Existing Conditions



DRINKING FOUNTAIN - EXISTING CONDITIONS

NOT TO SCALE

GENERAL NOTES

- 1 GENERAL CONTRACTOR SHALL CAREFULLY DISCONNECT, REMOVE AND TURN OVER TO DISTRICT THE EXISTING BOTTLE FILLER.
- 2 GENERAL CONTRACTOR SHALL CUT AND PATCH EXISTING CERAMIC TILE, DRYWALL INCLUDING PAINT, AND FLOORING AS REQUIRED TO INSTALL NEW WORK. PATCHING SHALL MATCH EXISTING CONSTRUCTION AND FINISH.
- 3- GENERAL CONTRACTOR DEMOLISH THE EXISTING HAND RAILS AND PATCH FLOOR TO MATCH EXISTING CONSTRUCTION AND FINISH.
- 4- GENERAL CONTRACTOR SHALL INTERCEPT, RE-ROUT AND EXTEND EXISTING PLUMBING AS REQUIRED TO MAKE FINAL CONNECTIONS TO THE NEW HIGH LOW DRINKING FOUNTAIN. THIS SHALL INCLUDE INSTALLING WATER FILTER MODEL 6426, 10"x 2" IN-LINE LEAD REMOVAL ELEMENT.
- 5 GENERAL CONTRACTOR SHALL INTERCEPT, RE-ROUT AND EXTEND THE EXITING ELECTRICAL AND MAKE FINAL CONNECTION TO NEW HIGH LOW DRINKING FOUNTAIN.
- 6 GENERAL CONTRACTOR SHALL DEMOLISH EXISTING WALL MOUNTED DISPLAY CASE INCLUDING PATCH AND PAINT THE AREA TO MATCH ADJACENT WALL FINISH AND CONSTRUCTION.
- 7 GENERAL CONTRACTOR SHALL PROVIDE ALL ROUGH FRAMING AND BLOCKING REQUIRED FOR THE INSTALLATION OF THE NEW DRINKING FOUNTAIN.



401 NOGALES ST, SOUTH SAN JOSE HILLS, CA 91744

Project Address:

RESTROOM INTERIM HOUSING DISTRICT SCHOOL SCHOOL HIGH (UNIFIED ES <u>~</u> NOGAL PORTABLE LOCKER ROWLAND

PROJECT NUMBER:

2110000

Date: 10/10/2022


Addendum: 2

Client:

Sheet: CMSK - 4

Description:

DRINKING FOUNTAIN

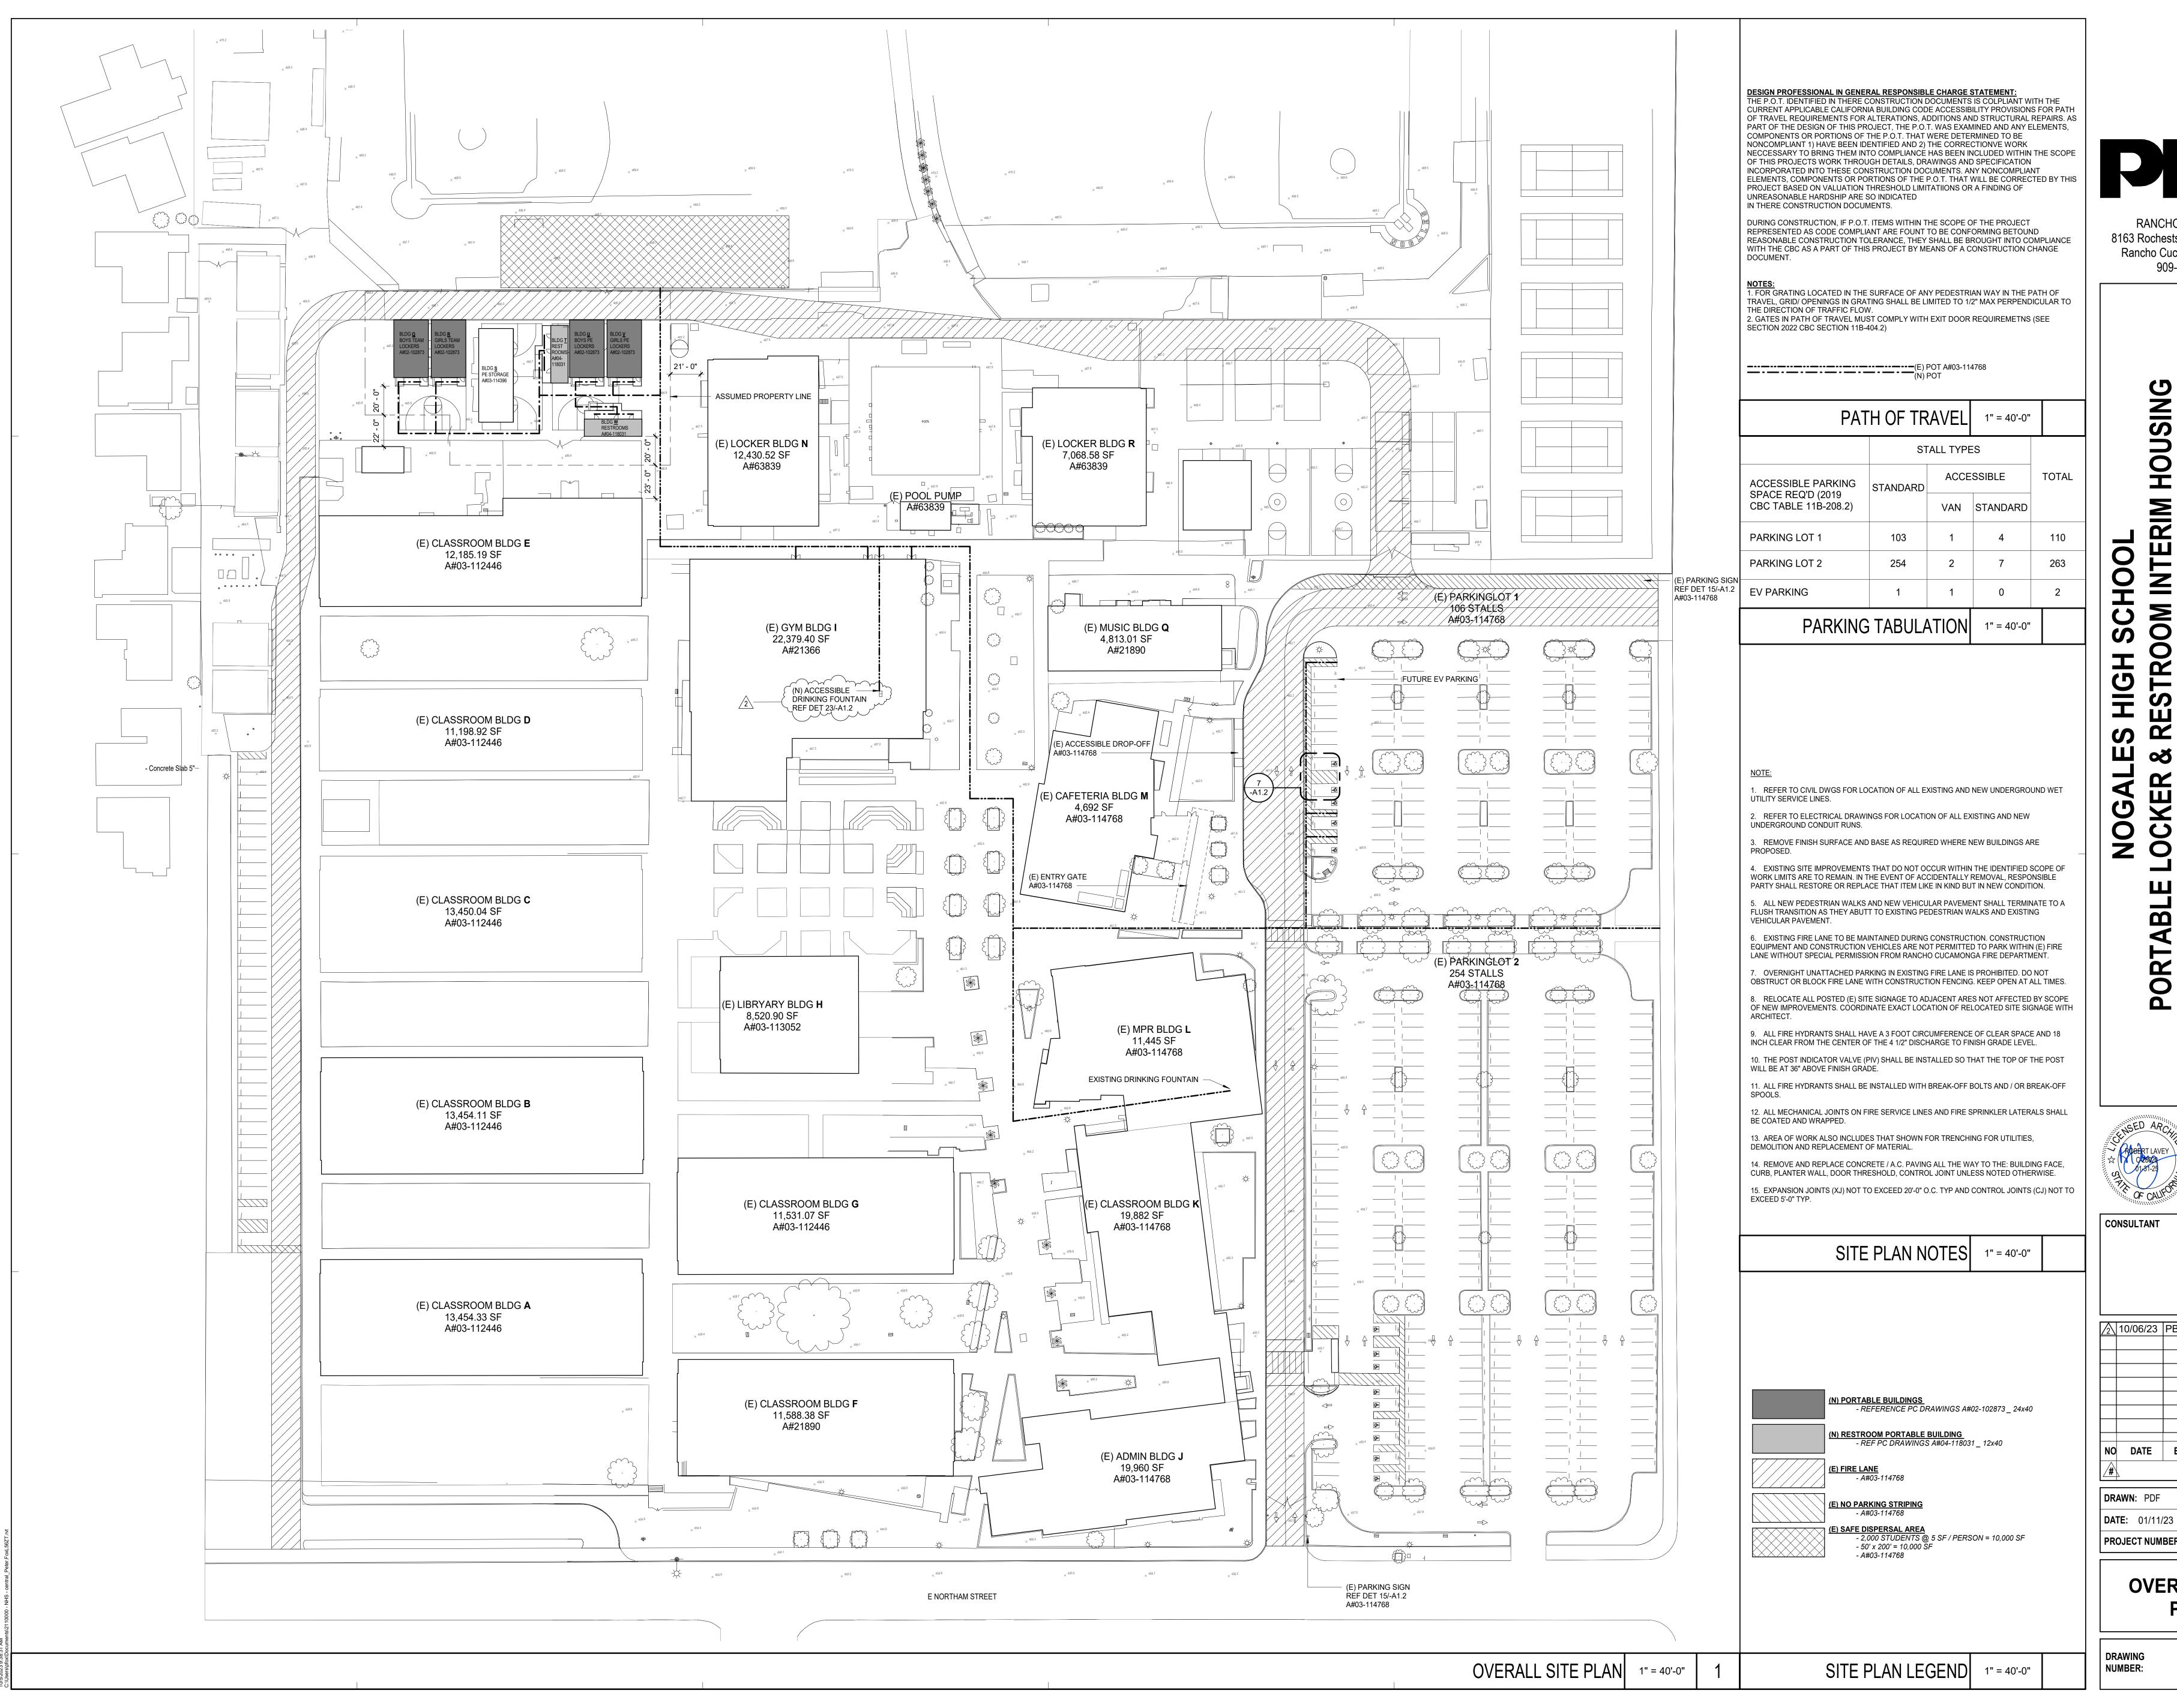

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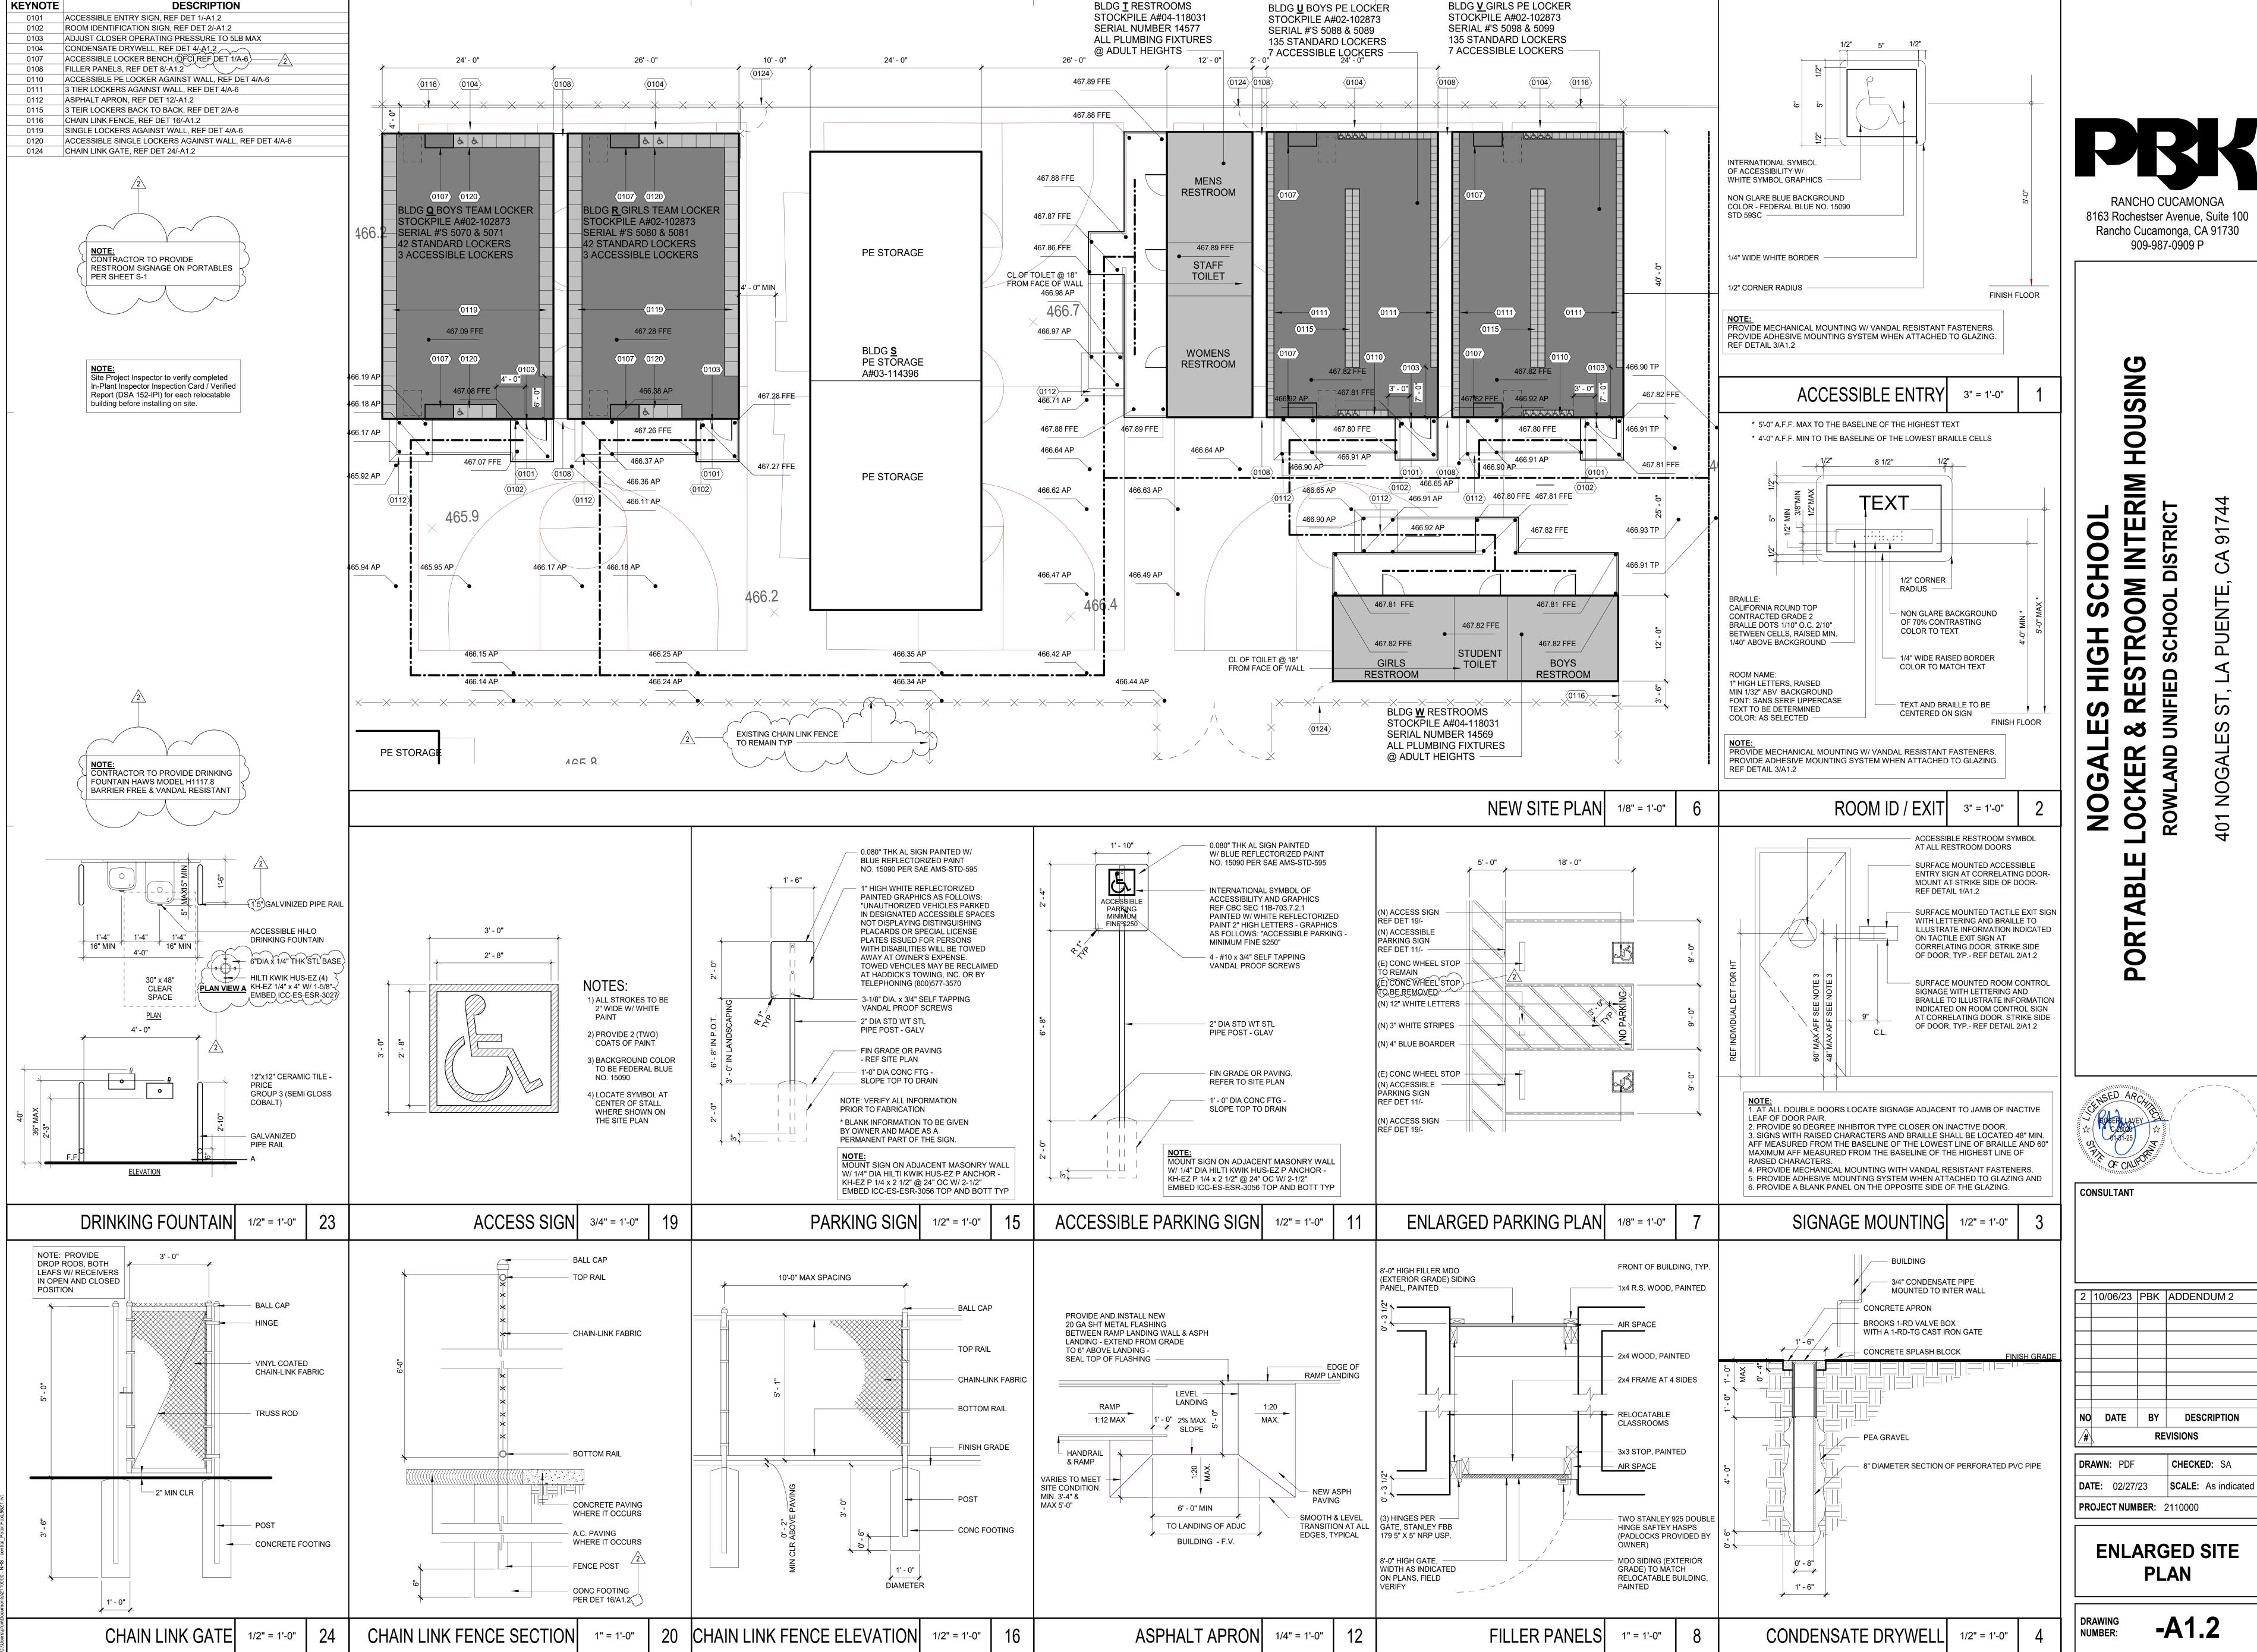


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| /2 | 10/06/23 | PRK | ADDENDUM 2 | |


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> **OVERALL SITE PLAN**


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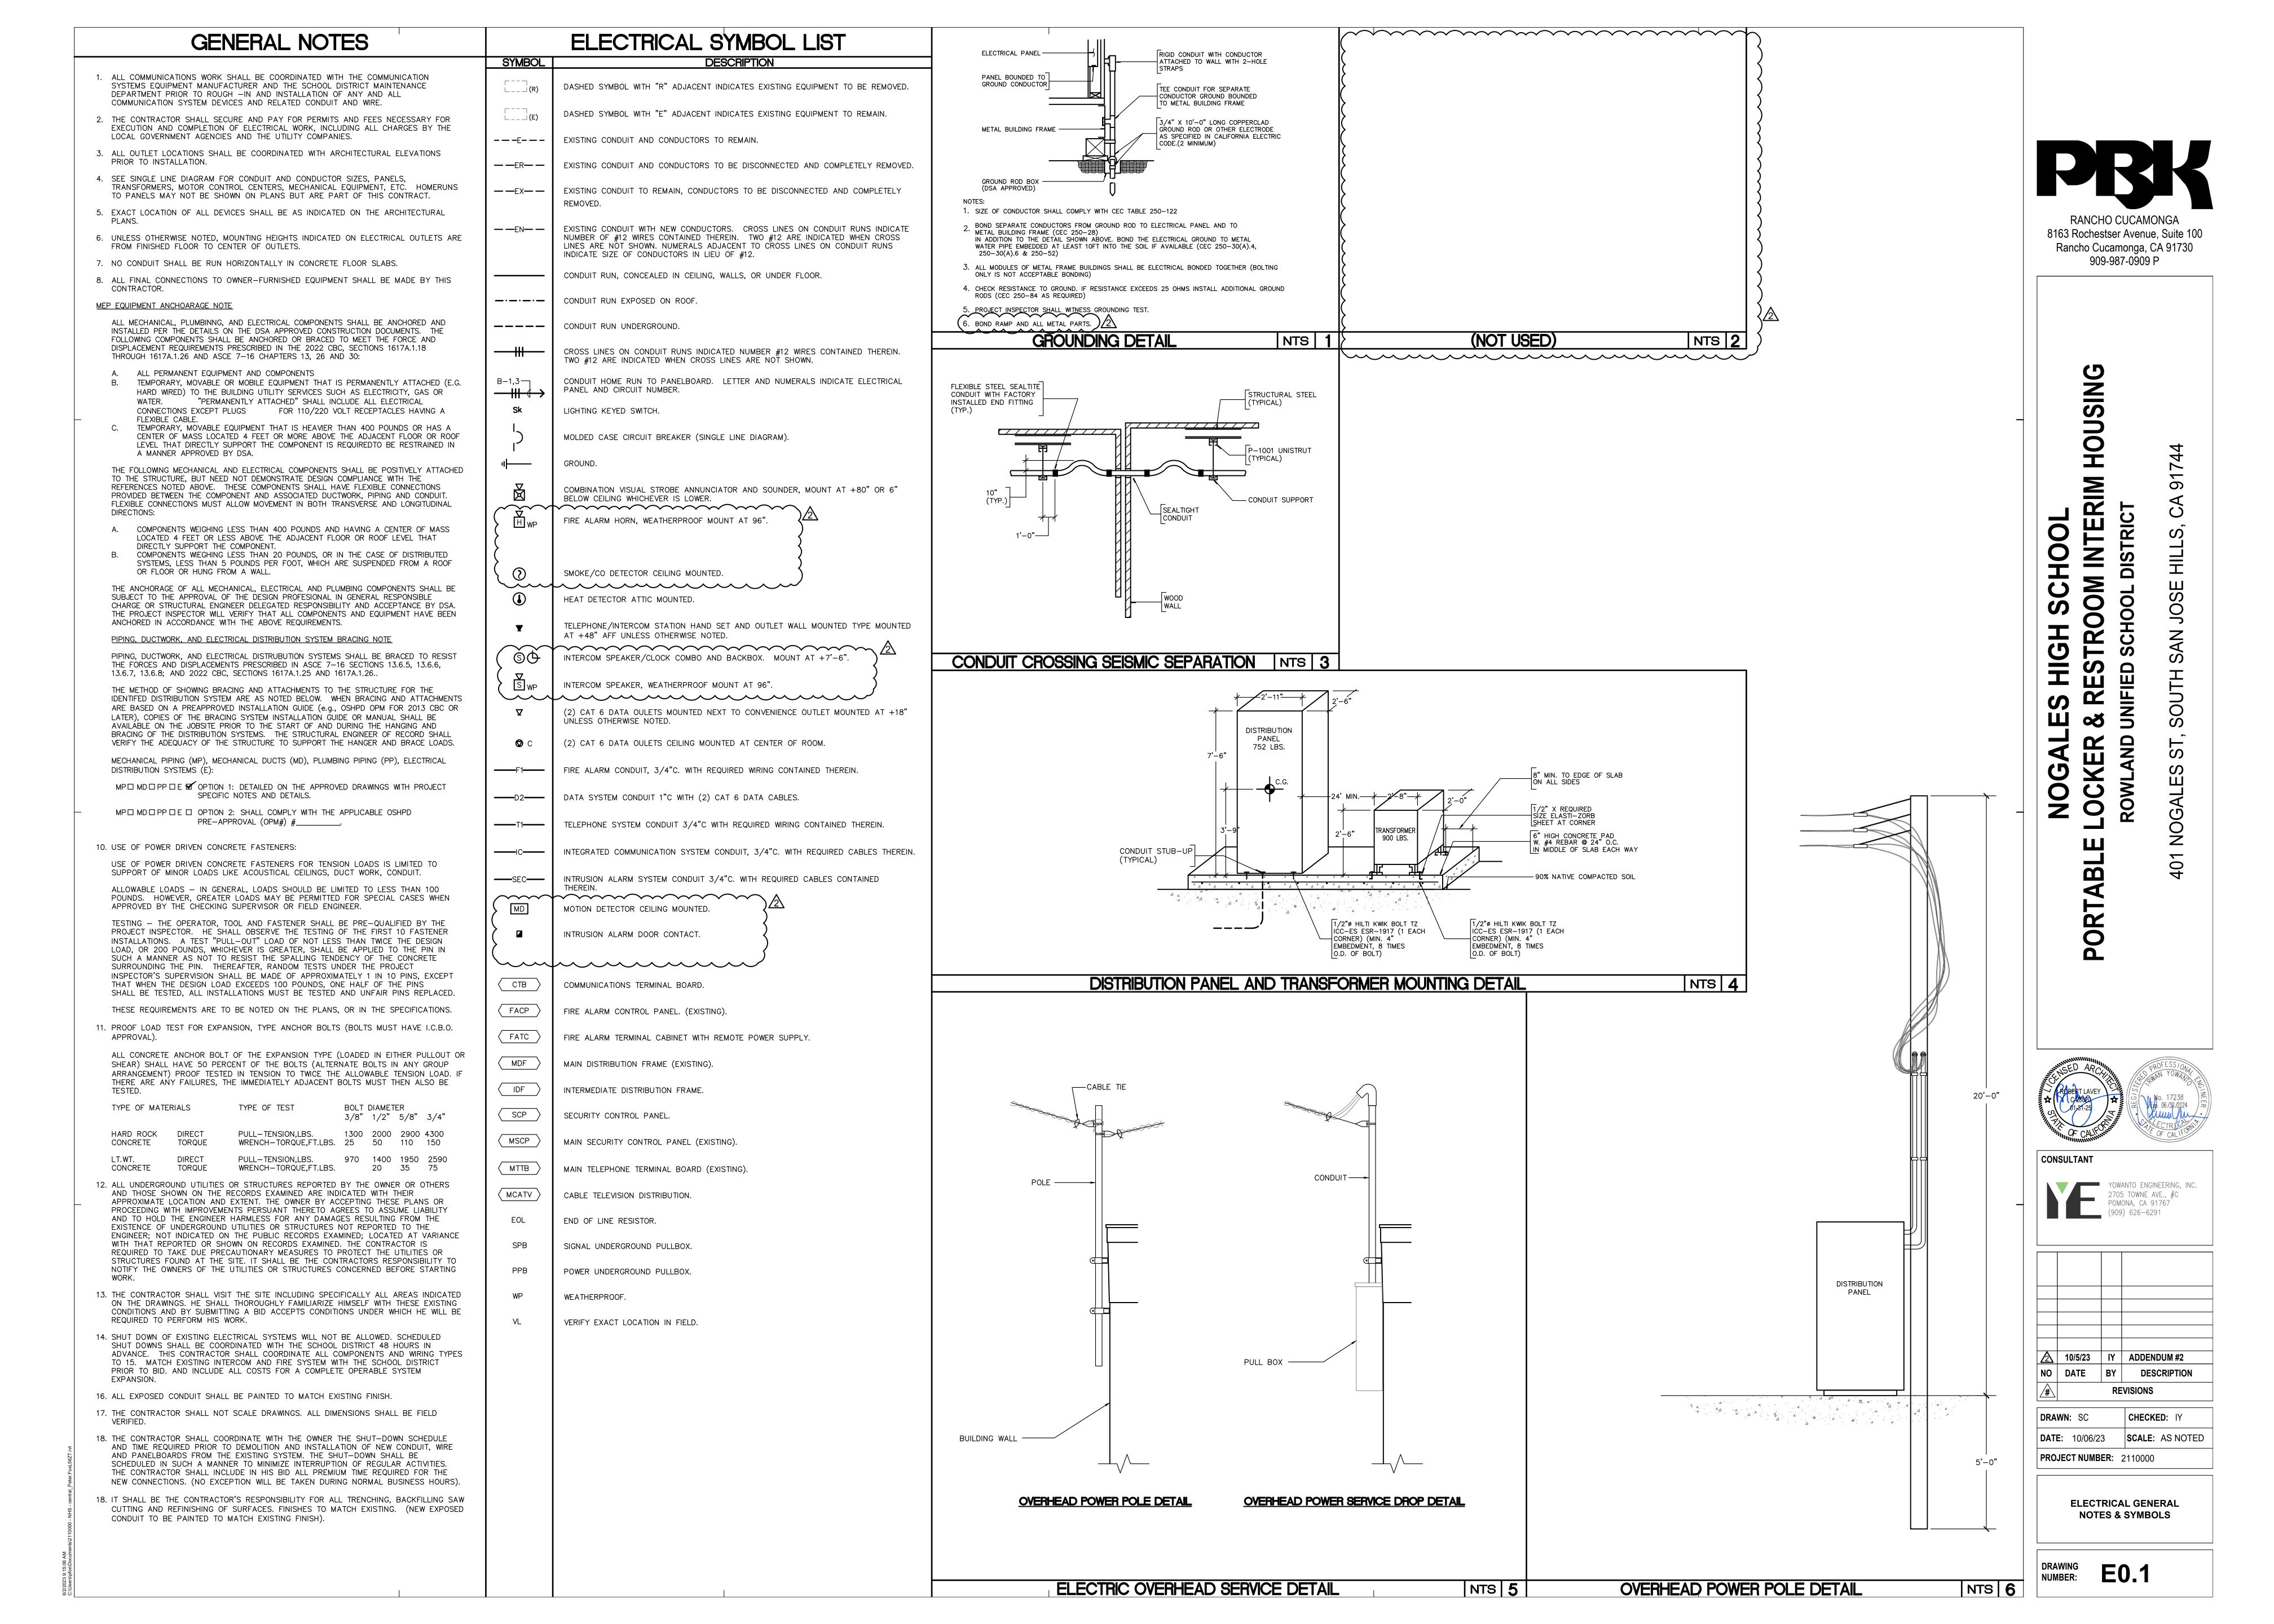








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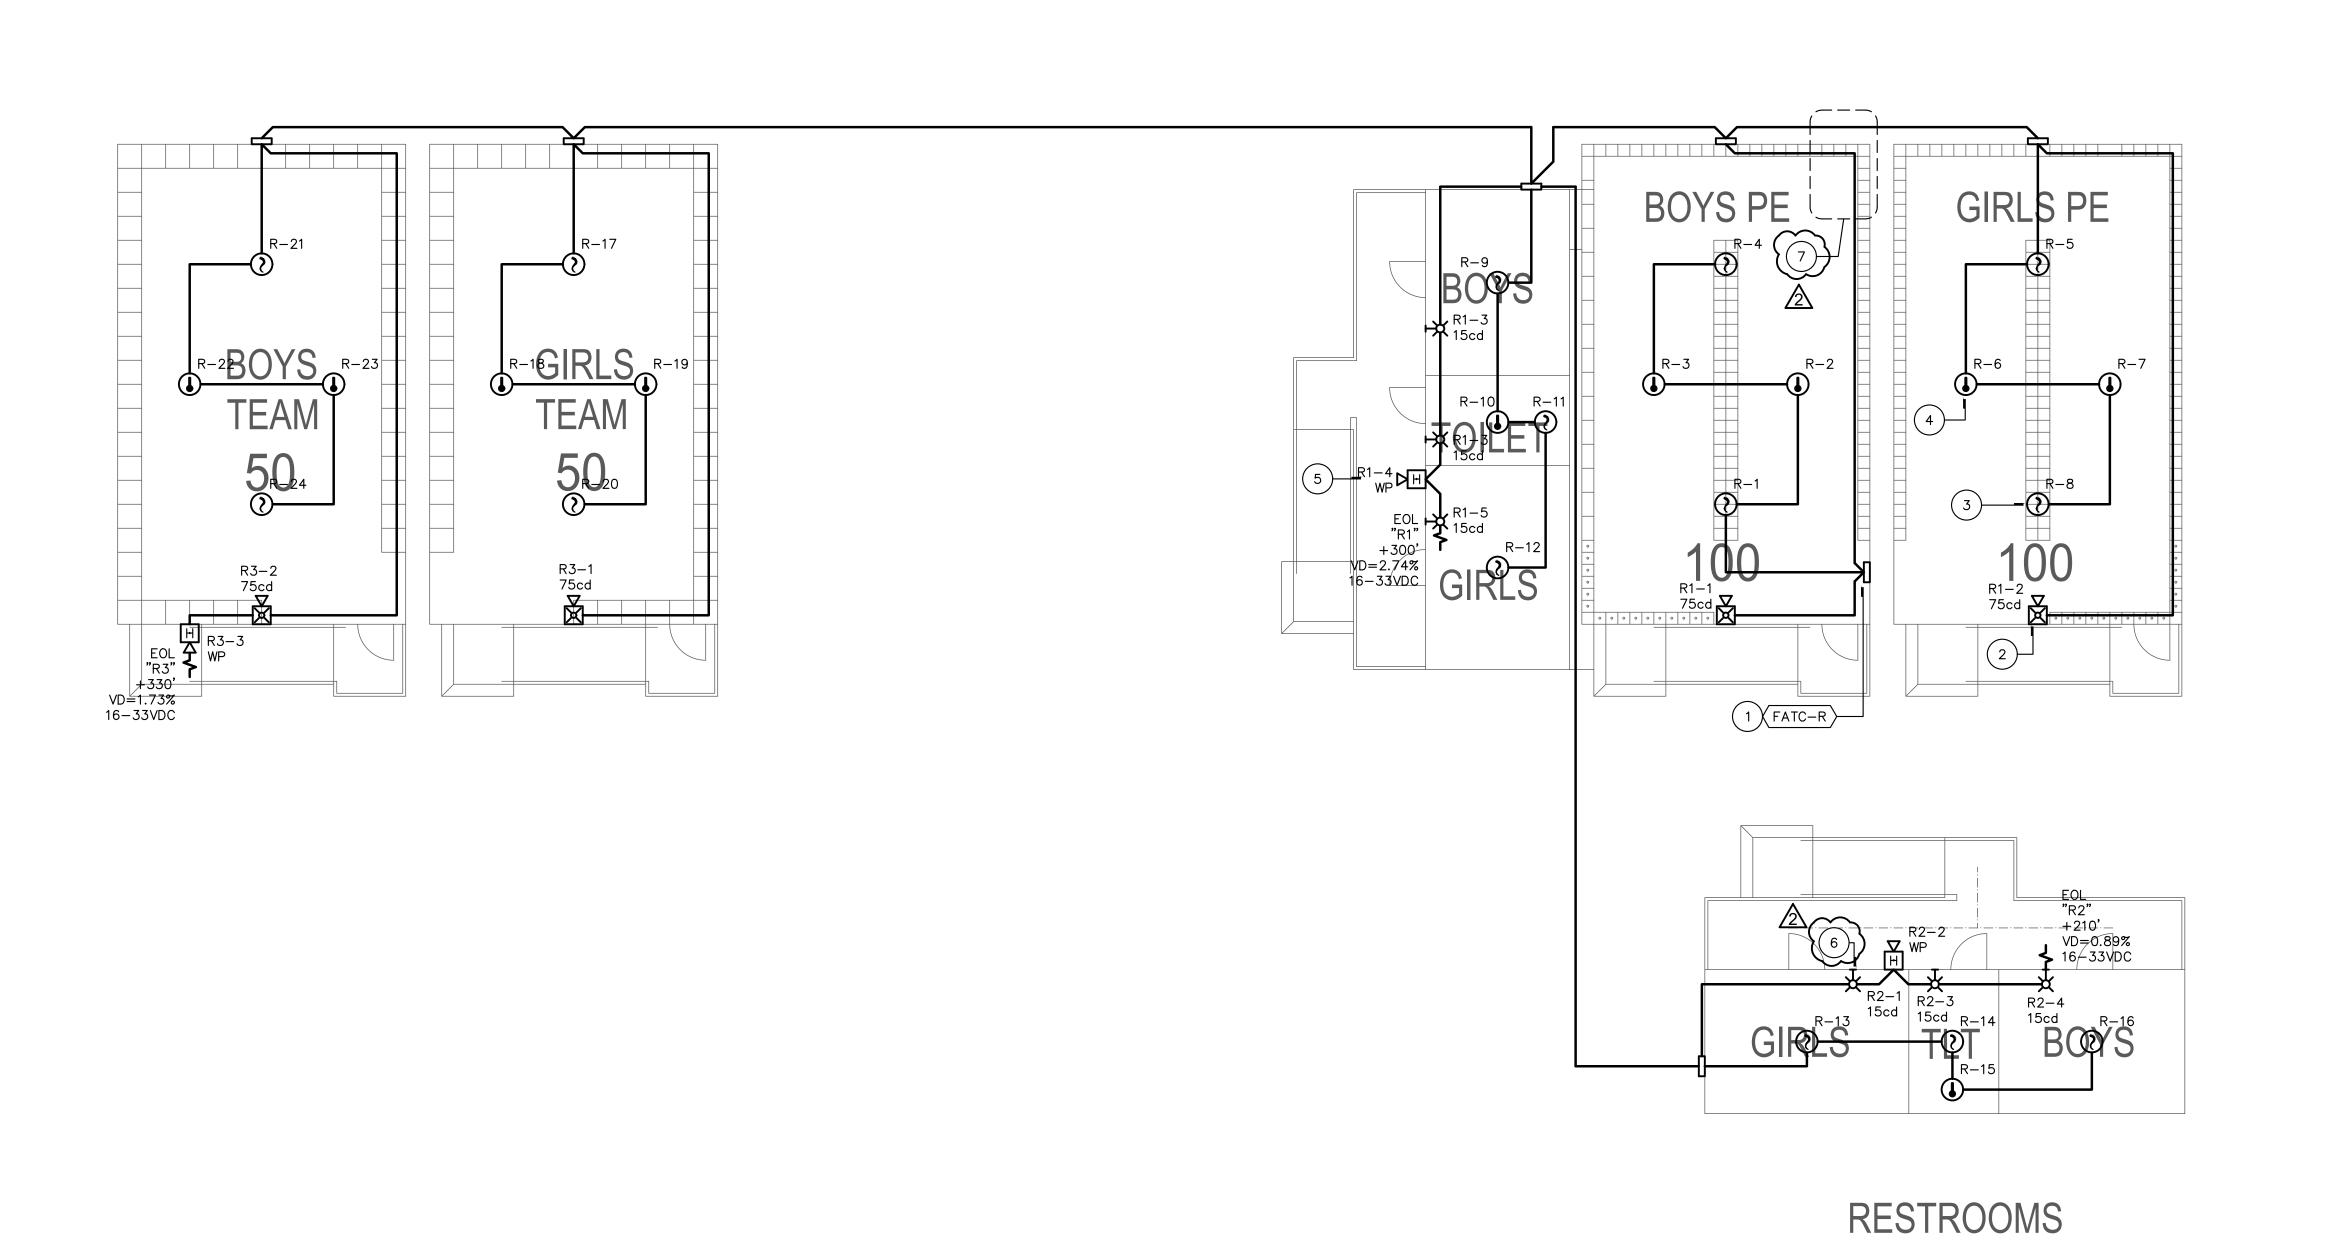
2705 TOWNE AVE., #C POMONA, CA 91767 (909) 626-6291

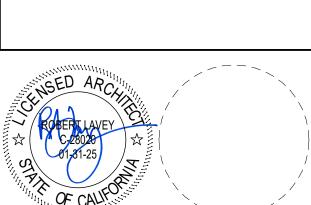10/5/23 IY ADDENDUM #2

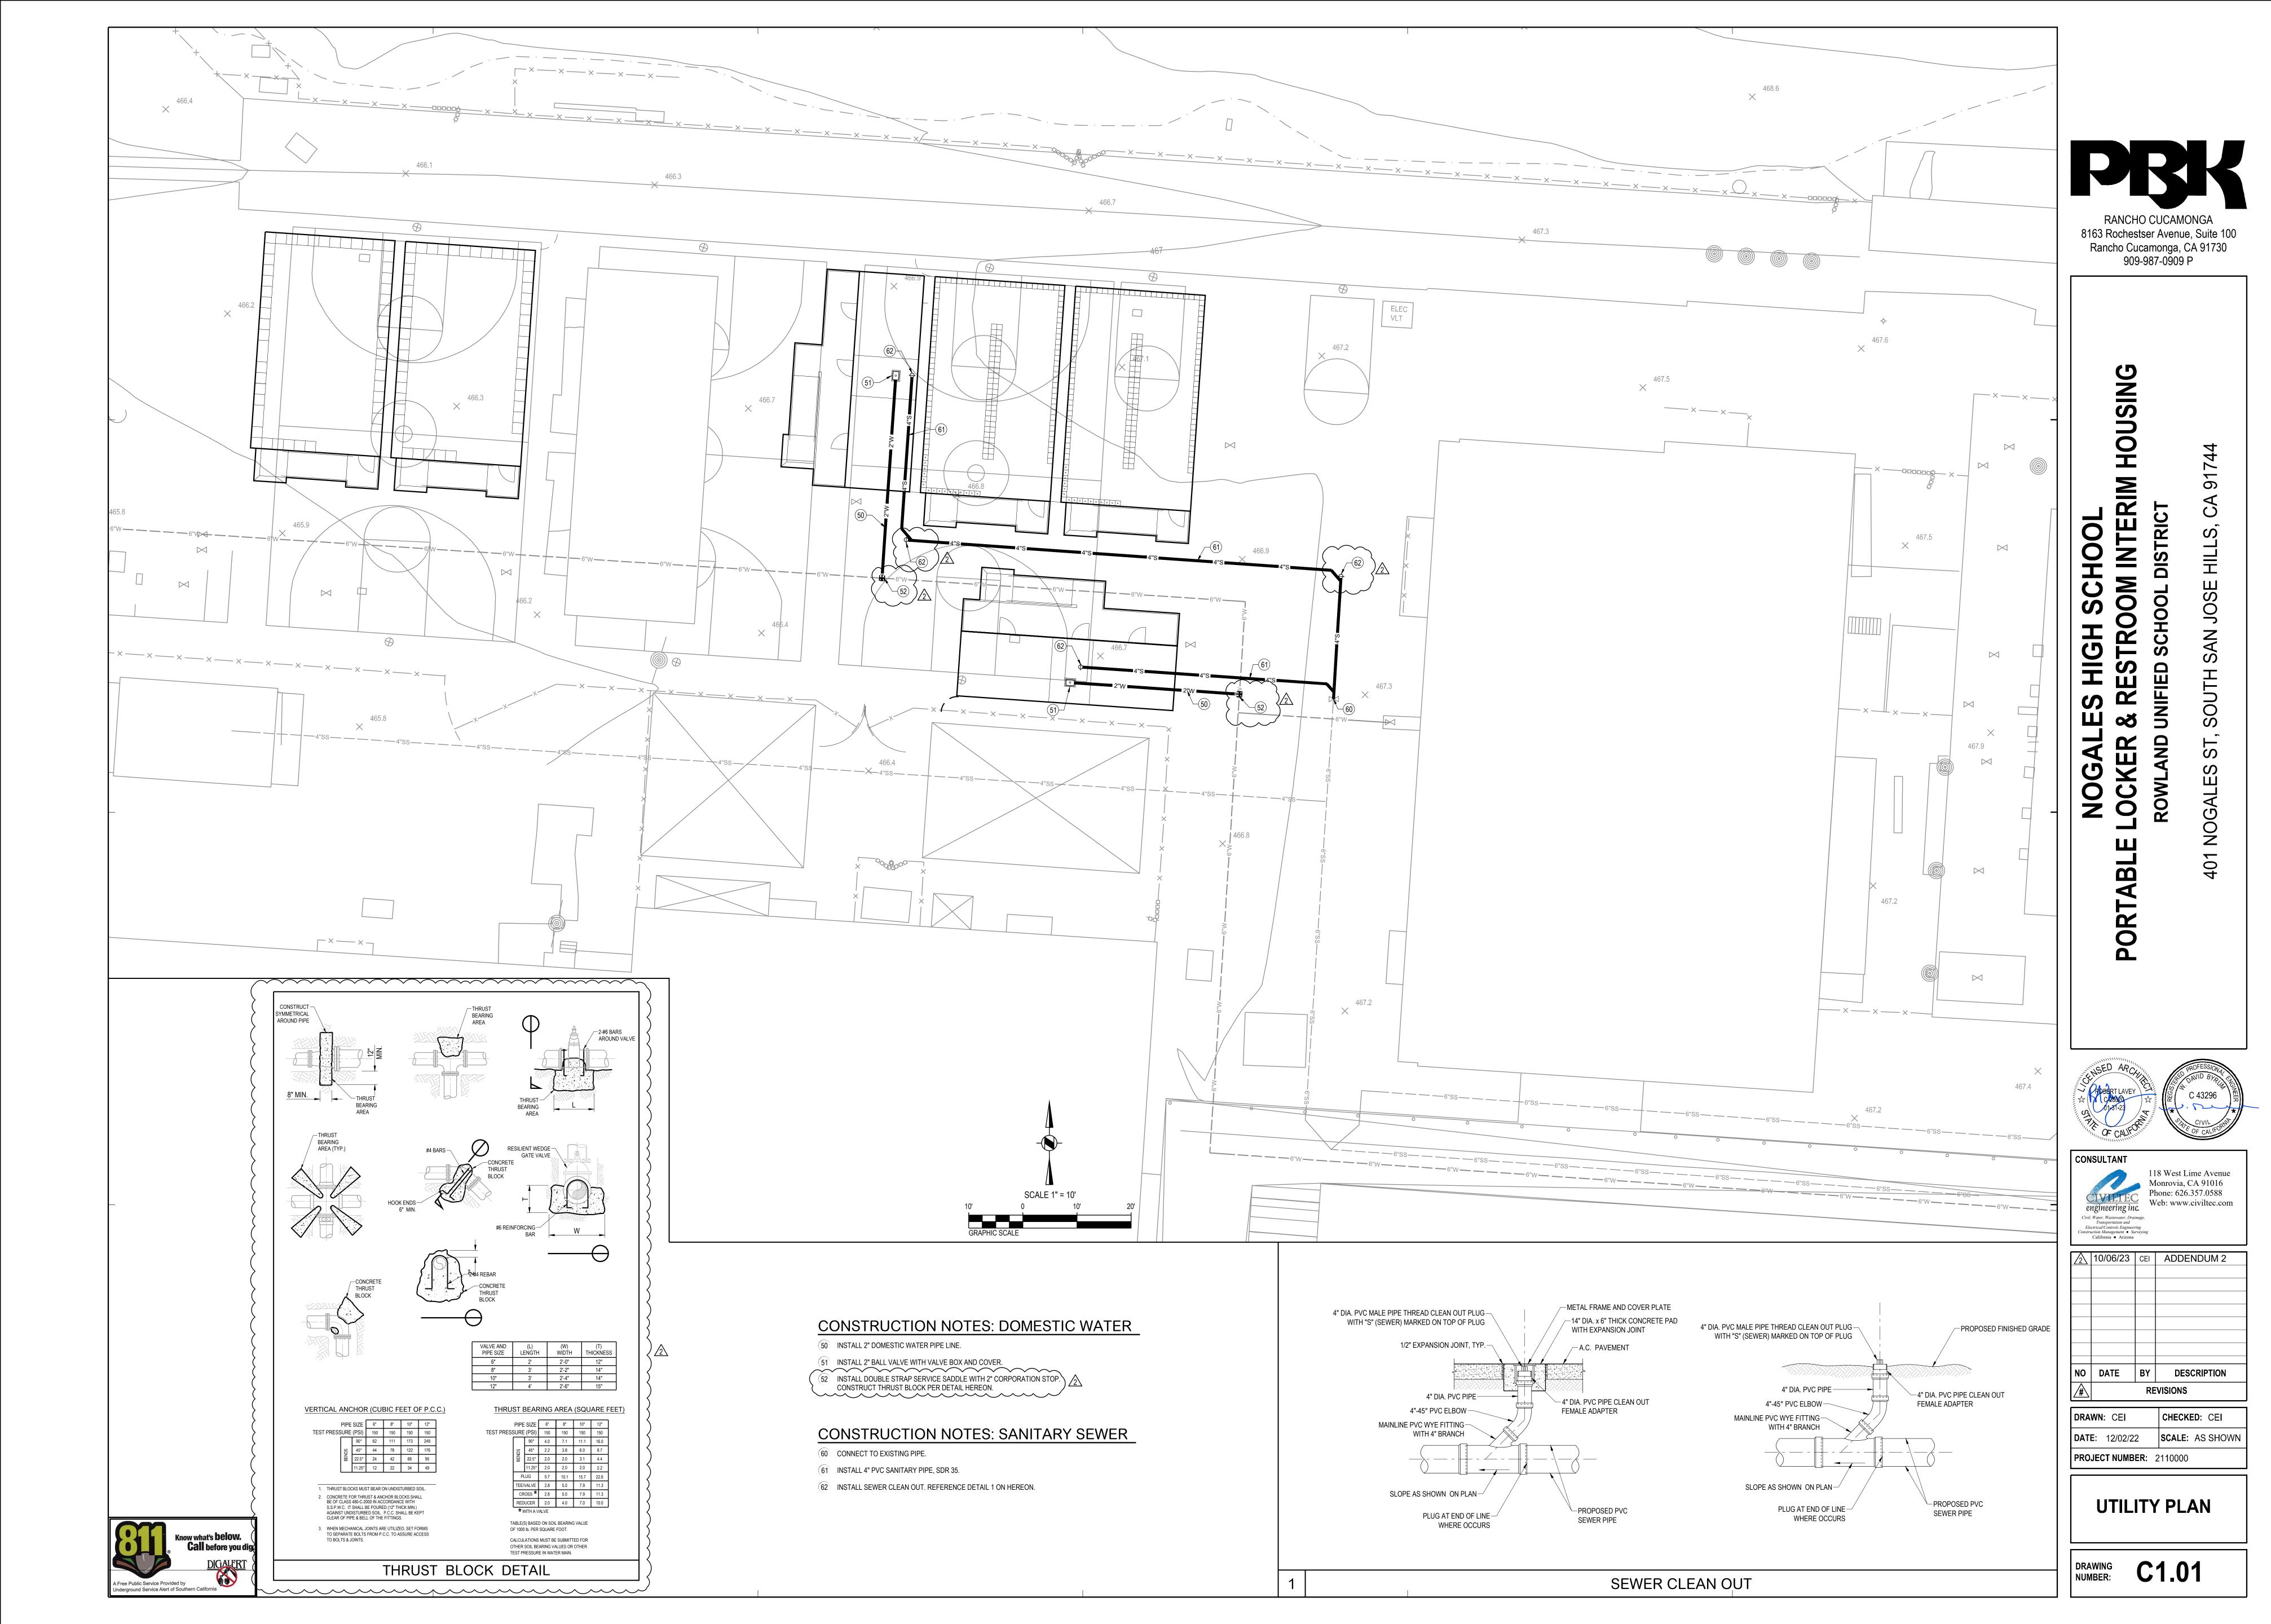DRAWN: SC **DATE**: 10/06/23

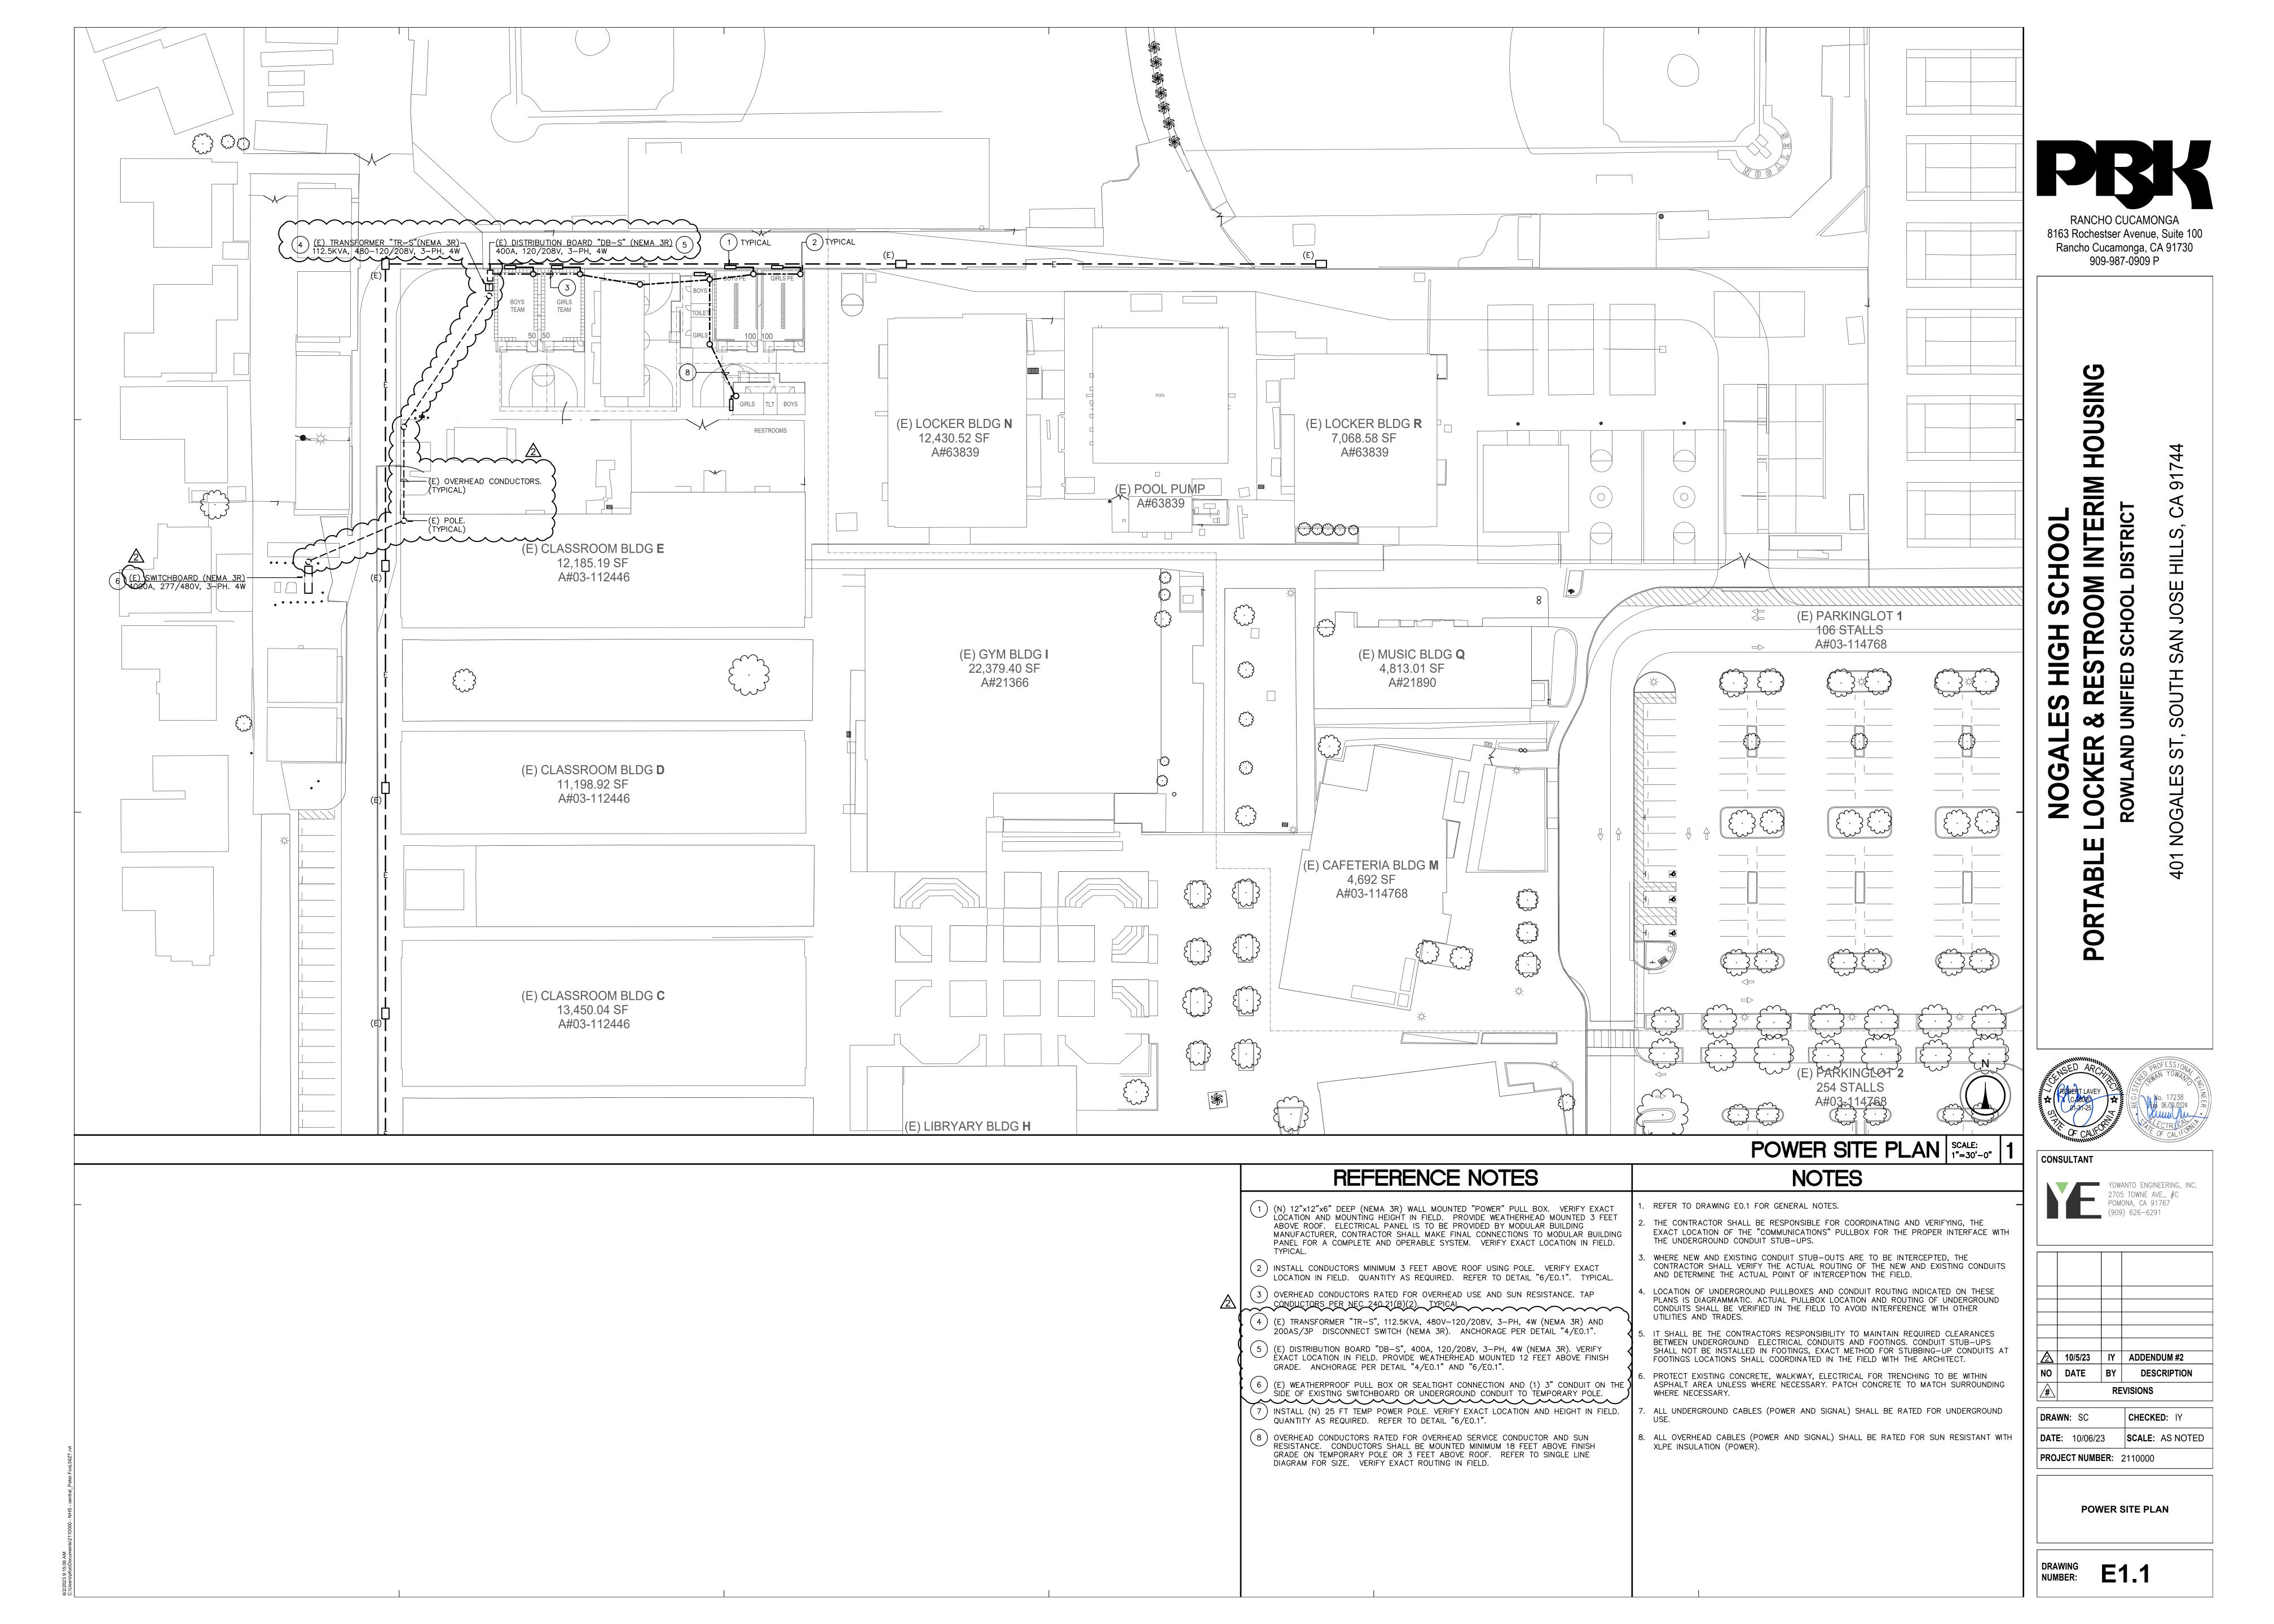SIGNAL SITE PLAN

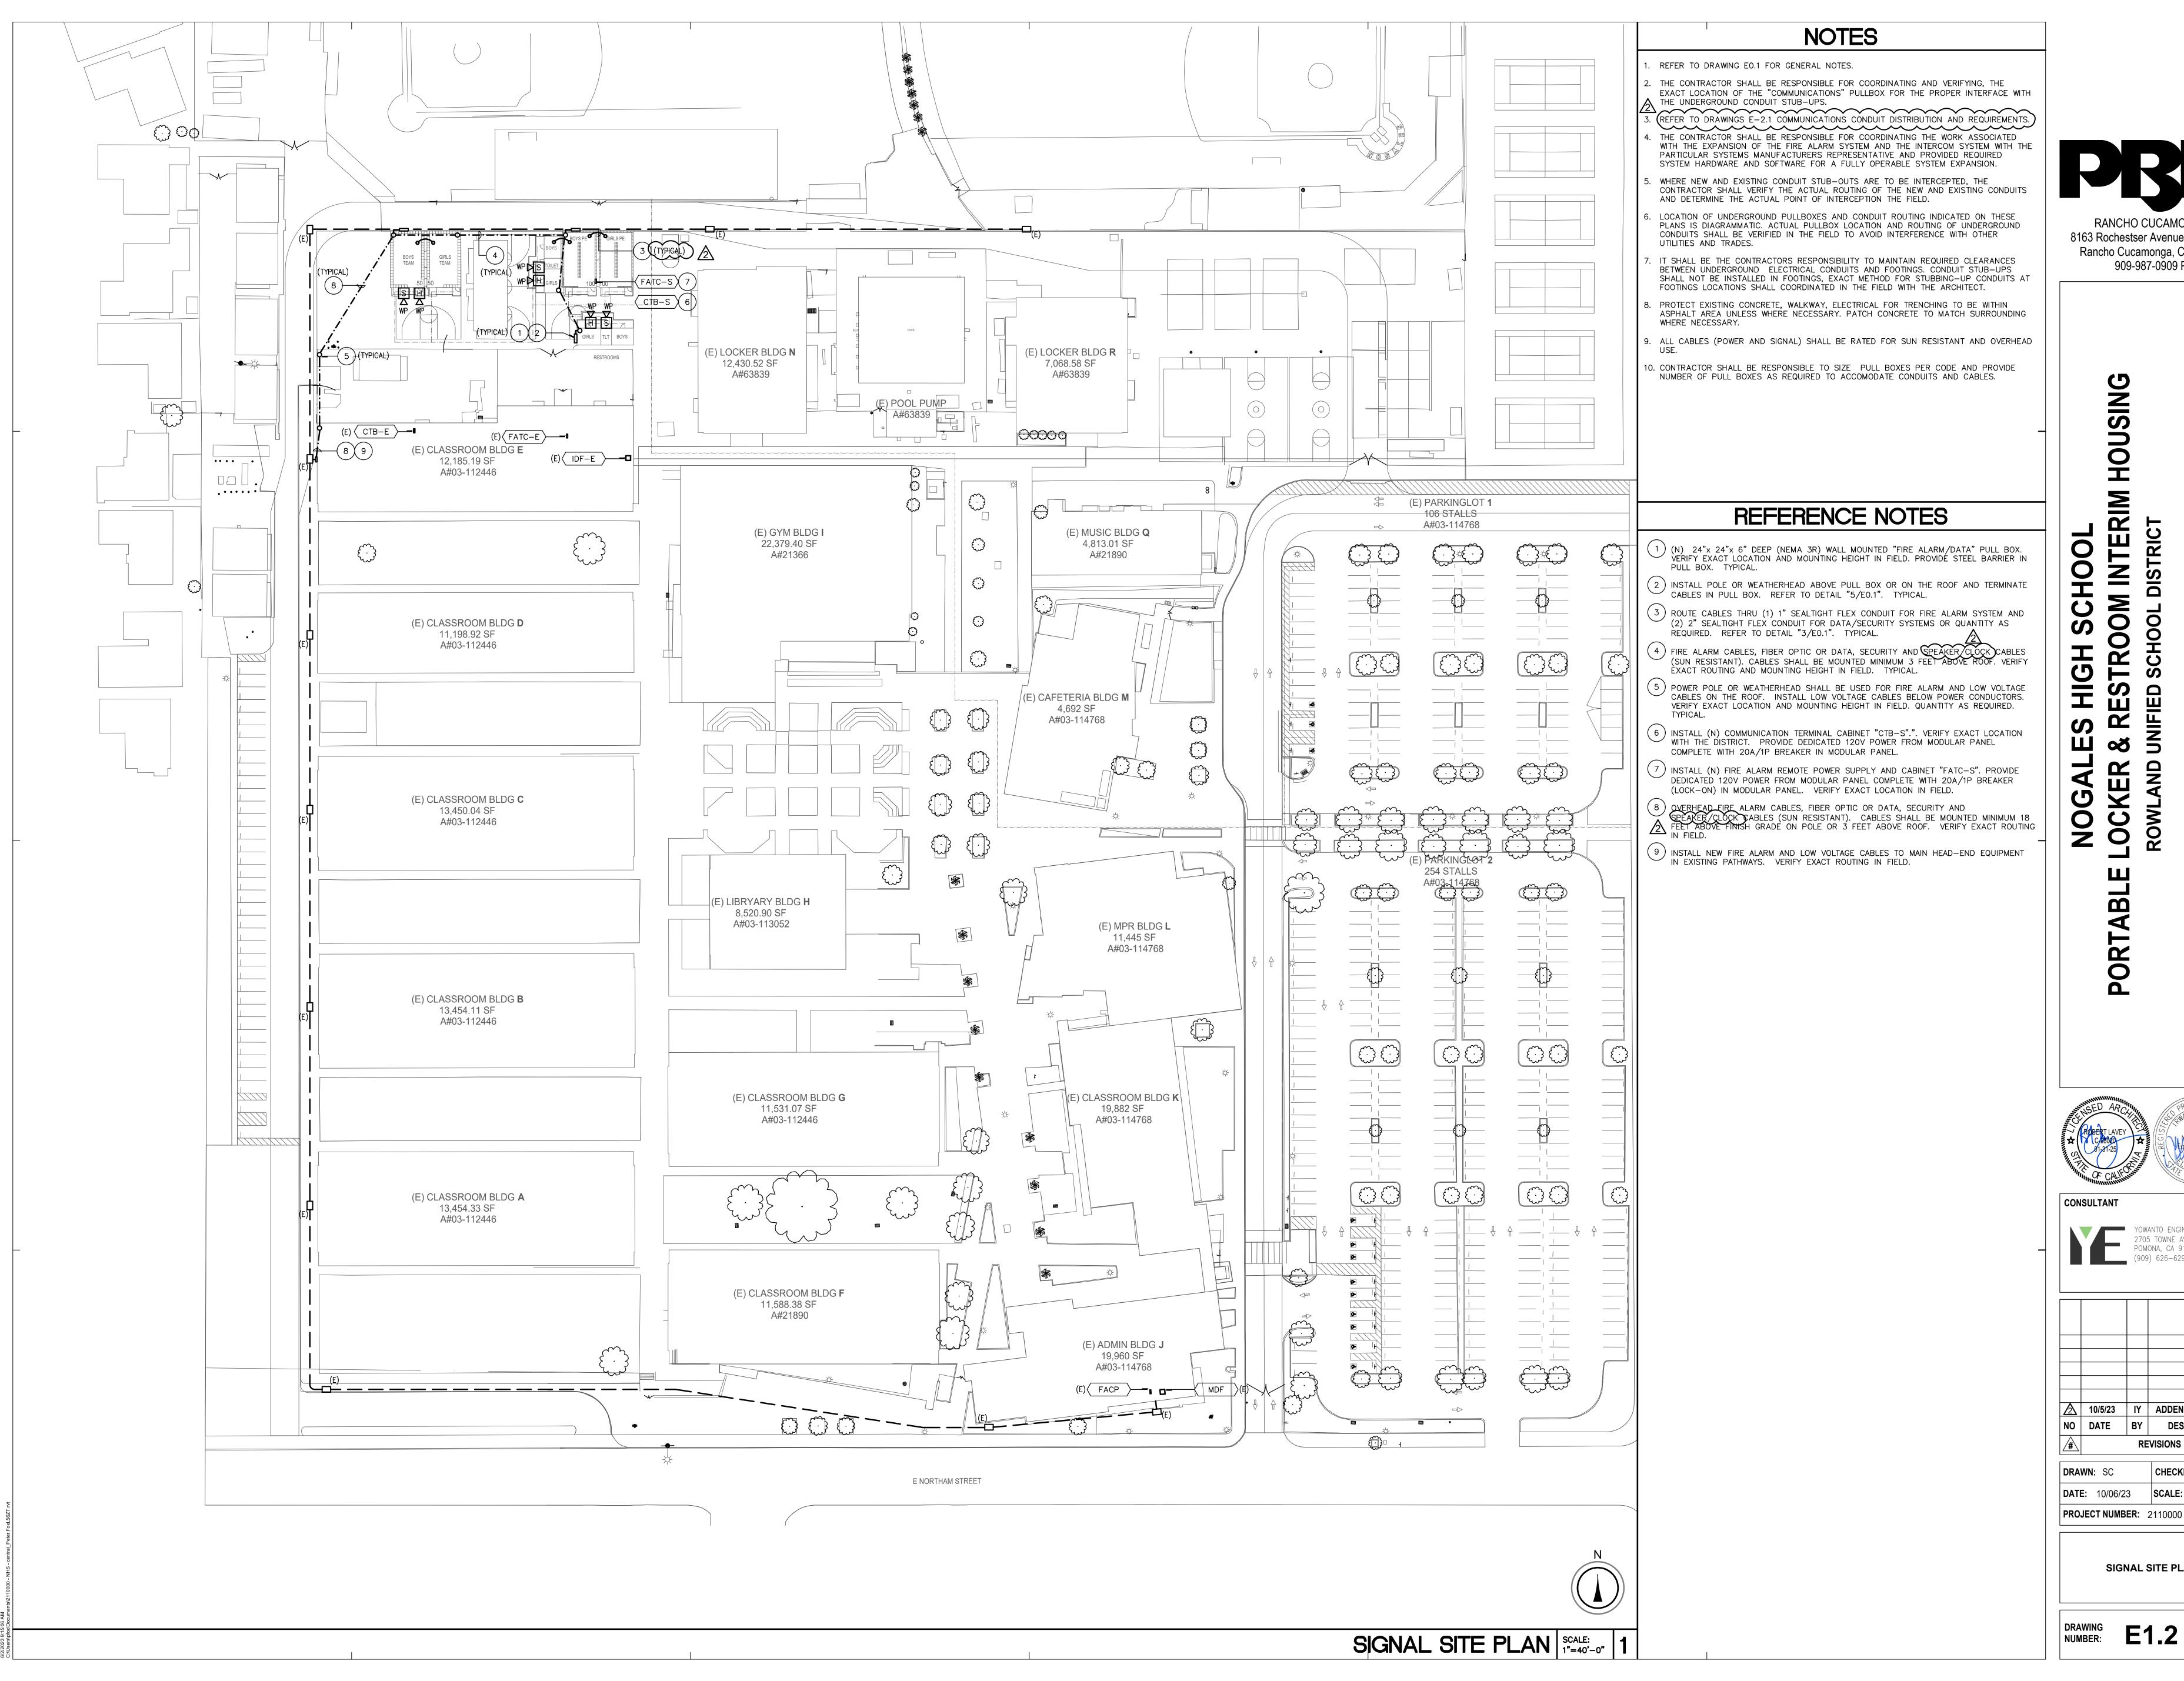DRAWING NUMBER: **E1.2**



GIRLS

TEAM

50

BOYS

TEAM

NOTES

- THE ELECTRICAL CONTRACTOR TO PROVIDE AND ROUGH-IN ALL NECESSARY LOW VOLTAGE AND FIRE ALARM SYSTEMS BACK BOXES, BUILDING MOUNTED TERMINAL BOXES AND ASSOCIATED CONDUITS (INCLUDING PULL-ROPE), BETWEEN BACK BOX AND TERMINAL
- . THE ELECTRICAL CONTRACTOR SHALL FURNISH AND INSTALL ALL NEW LOW VOLTAGE COMMUNICATION/SIGNAL AND FIRE ALARM DEVICES TO MATCH EXISTING SITE SYSTEMS, HE SHALL ALSO FURNISH AND INSTALL ALL ASSOCIATED CABLING REQUIRED AND MAKE ALL FINAL CONNECTIONS TO PROVIDE A FULLY FUNCTIONAL SYSTEM EXPANSION. COORDINATE ALL SPECIFIC REQUIREMENTS WITH THE LOCAL REPRESENTATIVE FOR "FCI/GAMEWELL" (FIRE ALARM) AND "BOGEN" (COMMUNICATIONS).
- 5. COORDINATE AND VERIFY WITH DEVICES MANUFACTURER FOR JUNCTION BOX SIZE REQUIRED FOR FUTURE INSTALLATION.
- 4. MOUNTING HEIGHT SHALL COMPLY WITH ADA REQUIREMENTS AND AS NOTED ON PLAN.
- WHERE EXISTING CONDUIT STUB-OUTS ARE TO BE INTERCEPTED, THE CONTRACTOR SHALL VERIFY THE ACTUAL ROUTING OF THE EXISTING CONDUITS AND DETERMINE THE ACTUAL POINT OF INTERCEPTION THE FIELD.
- 6. COORDINATE AND VERIFY EXACT LOCATION AND MOUNTING HEIGHT OF JUNCTION BOXES.
- '. COORDINATE AND VERIFY WITH DEVICES MANUFACTURER FOR JUNCTION BOX SIZE REQUIRED FOR FUTURE INSTALLATION.
- B. REFER TO NFPA 72 FOR MOUNTING HEIGHT, LOCATION AND SPACING OF FIRE ALARM DEVICES. CONTRACTOR SHALL BE RESPONSIBLE TO PROVIDE SMOKE DETECTORS, ATTIC HEAT DETECTOR, FIRE ALARM HORN/STROBE AND FIRE ALARM EXETRIOR HORN TO COMPLY WITH NFPA 72 FOR COVERÁGE.
- 9. REFER TO DRAWING EO.1 FOR GENERAL NOTES.
- 10. THE CONTRACTOR SHALL BE RESPONSIBLE FOR COORDINATING AND VERIFYING, THE EXACT LOCATION OF THE "COMMUNICATIONS" PULLBOX FOR THE PROPER INTERFACE WITH THE UNDERGROUND CONDUIT STUB-UPS.
- 11. THE CONTRACTOR SHALL BE RESPONSIBLE FOR COORDINATING THE WORK ASSOCIATED WITH THE EXPANSION OF THE FIRE ALARM SYSTEM AND THE INTERCOM SYSTEM WITH THE PARTICULAR SYSTEMS MANUFACTURERS REPRESENTATIVE AND PROVIDED REQUIRED SYSTEM HARDWARE AND SOFTWARE FOR A FULLY OPERABLE SYSTEM EXPANSION.
- 12. WHERE EXISTING CONDUIT STUB-OUTS ARE TO BE INTERCEPTED, THE CONTRACTOR SHALL VERIFY THE ACTUAL ROUTING OF THE EXISTING CONDUITS AND DETERMINE THE ACTUAL POINT OF INTERCEPTION THE FIELD.

F.A. REFERENCE NOTES

- INSTALL (N) FIRE ALARM REMOTE POWER SUPPLY AND CABINET "FATC-S". PROVIDE DEDICATED 120V POWER FROM MODULAR PANEL COMPLETE WITH 20A/1P LOCK-ON BREAKER IN MODULAR PANEL. VERIFY EXACT LOCATION IN FIELD. 2 INSTALL WALL MOUNTED FIRE ALARM HORN/STROBE AND FIRE ALARM CABLE TO
- 3) INSTALL SMOKE/CO DETECTOR AND FIRE ALARM CABLE TO "FATC-S". OWNER FURNISHED CONTRACTOR INSTALL. TYPICAL.

"FATC-S". OWNER FURNISHED CONTRACTOR INSTALL. TYPICAL.


- (4) INSTALL ATIC HEAT DETECTOR AND FIRE ALARM CABLE TO "FATC-S". OWNER FURNISHED CONTRACTOR INSTALL. TYPICAL.
- INSTALL WEATHERPROOF EXTERIOR FIRE ALARM HORN AND FIRE ALARM CABLE TO "FATC—S". OWNER FURNISHED CONTRACTOR INSTALL. TYPICAL.
- 6) INSTALL FIRE ALARM STROBE AND FIRE ALARM CABLE TO "FATC-S". OWNER FURNISHED CONTRACTOR INSTALL. TYPICAL.


FIRE ALARM FLOOR PLAN | SCALE: 1/8"=1'-0" | 1 | 7 REFER TO DETAIL "3/E-0.1" FOR CONDUIT SEISMIC SEPARATION DETAIL. TYPICAL.

SIGNAL REFERENCE NOTES

- (N) COMMUNICATION TERMINAL CABINET "CTB-S". VERIFY EXACT LOCATION WITH THE DISTRICT. PROVIDE DEDICATED 120V POWER FROM MODULAR PANEL COMPLETE WITH 20A/1P BREAKER IN MODULAR PANEL. INSTALL PLYWOOD BACKBOARD (SIZE AS REQUIRED) AND PAINT TO MATCH EXISTING WALL COLOR. VERIFY EXACT LOCATION IN
- INSTALL WALL MOUNTED SPEAKER/CLOCK COMBO AT +90" A.F.F. AND CABLES (WEST PENN #355 OR APPROVED EQUAL) TO EXISTING MAIN HEAD—END EQUIPMENT. TYPICAL INSTALL WALL MOUNTED WEATHERPROOF SPEAKER AND CABLES (WEST PENN #291 OR APPROVED EQUAL) TO EXISTING MAIN HEAD-END EQUIPMENT. TYPICAL.
- MSTALL CELLING OR CORNER MOUNT INTRUSION PIR MOTION DETECTOR AND CABLE (6#22 AWG) TO SECURITY PANEL. VERIFY EXACT LOCATION IN FIELD. TYPICAL.) INSTALL INTRUSION DOOR CONTACT AND CABLE (6#22 AWG) TO SECURITY PANEL. COORDINATE WITH DOOR HARDWARE CONTRACTOR. TYPICAL.
- INSTALL 24"x24"x12" DEEP OR SIZE AS REQUIRED (NEMA—3R) WALL MOUNTED "DATA/SEC/FA" PULLBOX. PROVIDE METAL BARRIER FOR FIRE ALARM CABLE. VERIFY EXACT LOCATION IN FIELD. TYPICAL.
- INSTALL (1) 1" SEALTIGHT FLEX CONDUIT FOR FIRE ALARM SYSTEM AND (2) 2" SEALTIGHT FLEX CONDUIT FOR DATA/SECURITY SYSTEMS OR QUANTITY AS REQUIRED. REFER TO DETAIL "3/E-0.1" FOR CONDUIT SEISMIC SEPARATION DETAIL TYPICAL. INSTALL EXTERIOR LED LIGHTING FIXTURE BY KENALL #M013ED-PP-MB-16L40K-DV-LEL-BPC COMPLETE WITH 90-MINUTE EMERGENCY BATTERY PACK AND PHOTO

CELL. CONNECT TO UNSWITCHED LIGHTING CIRCUIT. TYPICAL.

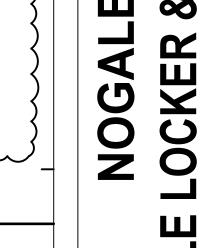

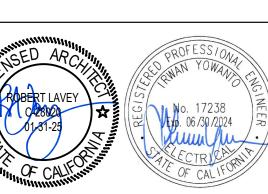

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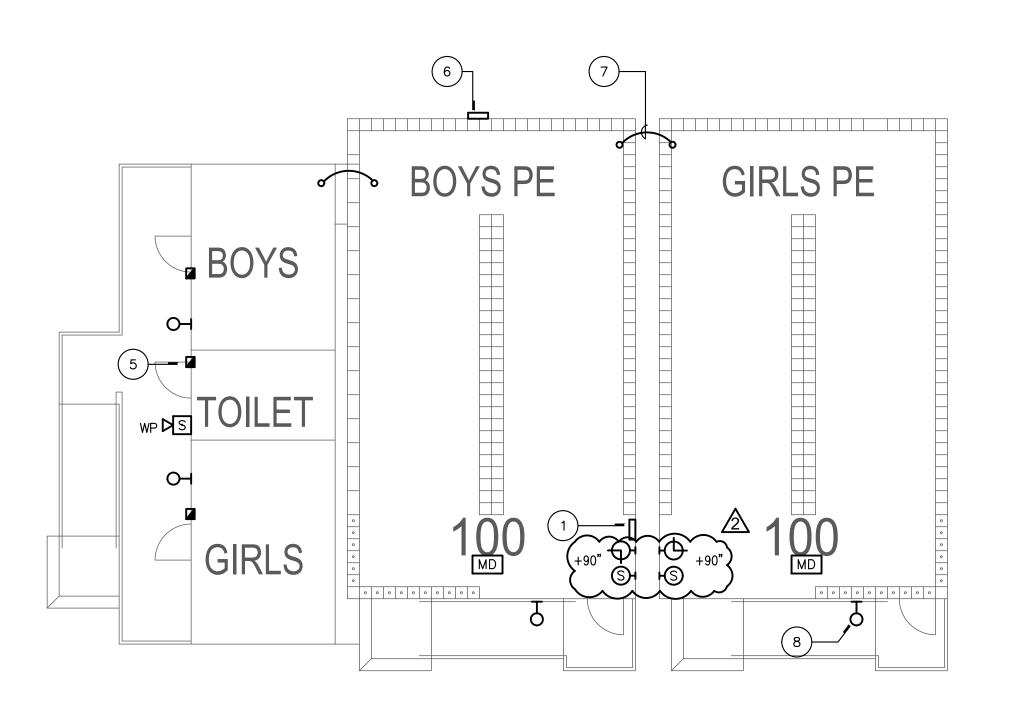
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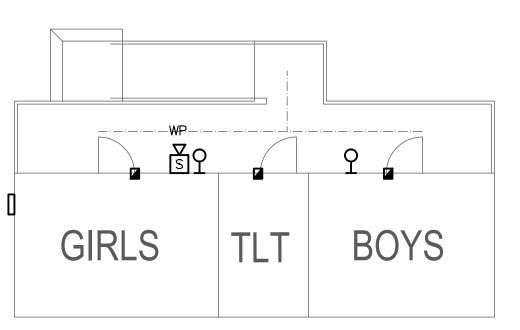
10/5/23 IY ADDENDUM #2

PROJECT NUMBER: 2110000

FIRE ALARM PLAN


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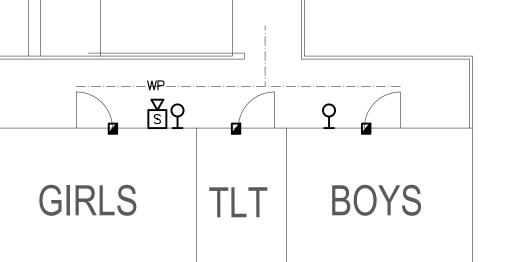




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SIGNAL FLOOR PLAN | SCALE: 1/8"=1'-0" 2



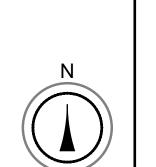


NOTES

- 1. THE CONTRACTOR SHALL BALANCE ALL SINGLE PHASE LOADS ON PHASE A AND B.
- 2. ALL SWITCHBOARDS AND DISTRIBUTION BOARDS SHALL BE FULLY
- 3. PROVIDE CONTINUOUS GROUND BUSSING THROUGH ALL DISTRIBUTION BOARDS AND SWITCHBOARD SECTIONS.
- 4. SERIES RATING OF EQUIPMENT IS NOT ALLOWED.
- 5. CONTRACTOR SHALL BOND ALL METAL PIPING SYSTEMS AND EXPOSED STRUCTURAL STEEL PER NEC 250.104.
- 6. PROVIDE NAMEPLATES FOR ALL MISSING IDENTIFICATIONS, USE SCREW-ON TYPE.
- 7. PROVIDE AND INSTALL NEW IDENTIFICATION NAMEPLATES ON ALL PANELS AS INDICATED ON PANEL SCHEDULES.
- 8. REFERENCES FEEDER LOCATION SHOWN ON E1.1 SITE PLAN.
- 9. THE CONTRACTOR SHALL PROVIDE AND INSTALL A NEW CIRCUIT BREAKER OF THE RATING INDICATED ON THE SINGLE LINE DIAGRAM TO MATCH EXISTING IN MANUFACTURER, FUNCTION AND SHORT CIRCUIT DUTY. THE NEW CIRCUIT BREAKER SHALL BE COMPLETE WITH ALL REQUIRED MOUNTING HARDWARE.
- 10. GROUND RESISTANCE SHALL NOT EXCEED 25 OHMS.
- 11. CONTRACTOR SHALL BE RESPONSIBLE TO RELOCATE EXISTING CIRCUIT BREAKERS AND MAKE NECESSARY ADJUSTMENT TO EXISTING CONDUCTORS TO MAKE ROOM FOR NEW CIRCUIT BREAKER IN EXISTING
- 12. OVERHEAD CONDUCTORS SHALL BE LISTED FOR OVERHEAD AND SUN RESISTANT RATED AT 90°C.
- 13. UNDERGROUND CONDUCTORS SHALL BE LISTED FOR UNDERGROUND USE AND WET LOCATION RATED AT 90°C.
- 14. LUGS SHALL BE LISTED FOR CU/AL AND 90°C.
- 15. FEEDER SHALL BE ALUMINUM (XLPE INSULATION FOR OVERHEAD AND XHHW-2 IN CONDUIT) UNLESS OTHERWISE NOTED.

REFERENCE NOTES

1 CONNECT NEW CONDUCTORS TO EXISTING CIRCUIT BREAKER.
2 INSTALL STEEL REINFORCED ALUMINUM OVERHEAD SECONDARY
CONDUCTORS (XLPE) BY ALCAN #APALOOSA OR APPROVED EQUAL.

- (E) (2) 2-1/2"C-4#250Kcmil & 1#1/0 GND CONDUCTORS (AL) BY STABILOY WITH XHWW-2 INSULATION (WET LOCATION) OR APPROVED EQUAL. VERIFY EXACT ROUTING IN FIELD.
- 4 INSTALL STEEL REINFORCED ALUMINUM OVERHEAD SECONDARY CONDUCTORS (XLPE) BY ALCAN #HACKNEY OR APPROVED EQUAL.
- (5) INSTALL STEEL REINFORCED ALUMINUM OVERHEAD SECONDARY CONDUCTORS (XLPE) BY ALCAN #COSTENA OR APPROVED EQUAL.

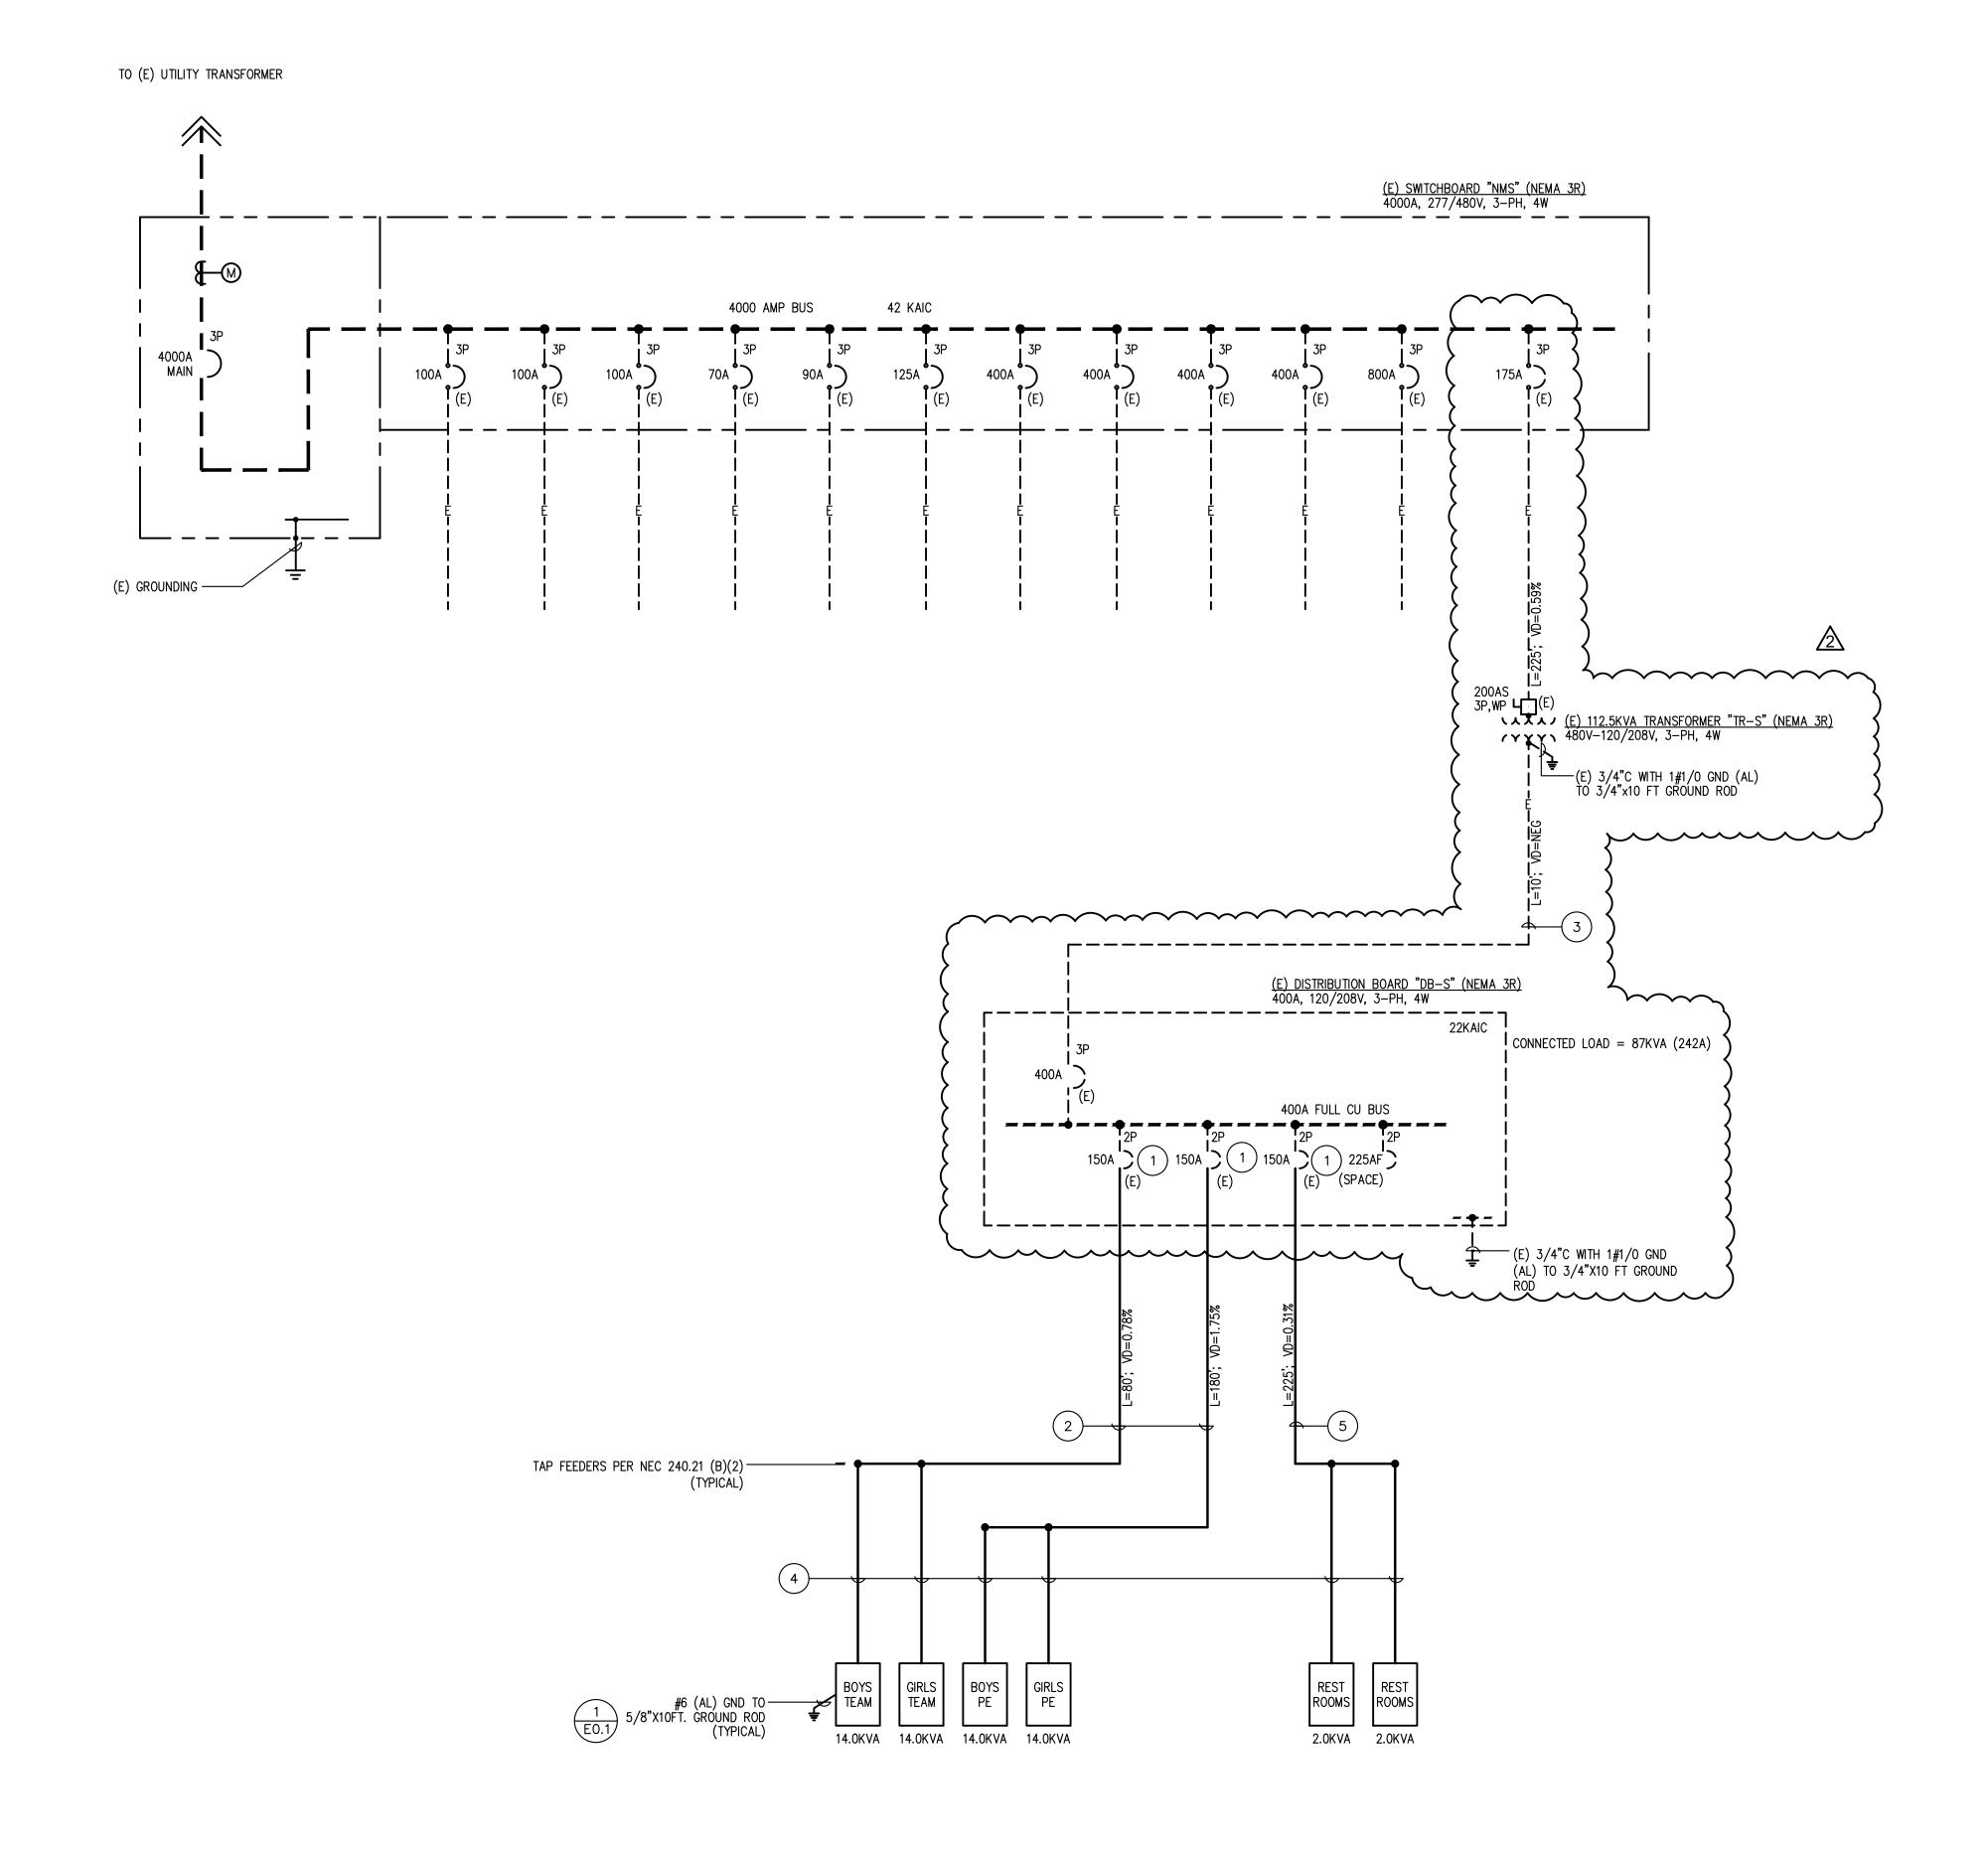



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| <u>A</u> | 10/5/23 | ΙΥ | ADDENDUM #2 | | | |
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DATE: 10/06/23 | SCALE: AS NOTED PROJECT NUMBER: 2110000

> SINGLE LINE AND **AV WIRING DIAGRAM**

DRAWING NUMBER: E4.1

SINGLE LINE DIAGRAM